
PERMIT ATTACHMENT
APPENDIX I

RCRA PART A

PERMIT APPLICATION

This document was altered from the April
2016 Application to duplicate two maps from
Tab 2 into Tab 1.

September 2018

APPENDIX I

RCRA PART A

PERMIT APPLICATION

FOR

SIEMENS INDUSTRY, INC.

PARKER REACTIVATION FACILITY

PARKER, ARIZONA


Revision 1
April 2012

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REVISED RCRA PART A PERMIT APPLICATION



**PARKER,
ARIZONÁ**

OCTOBER 1996

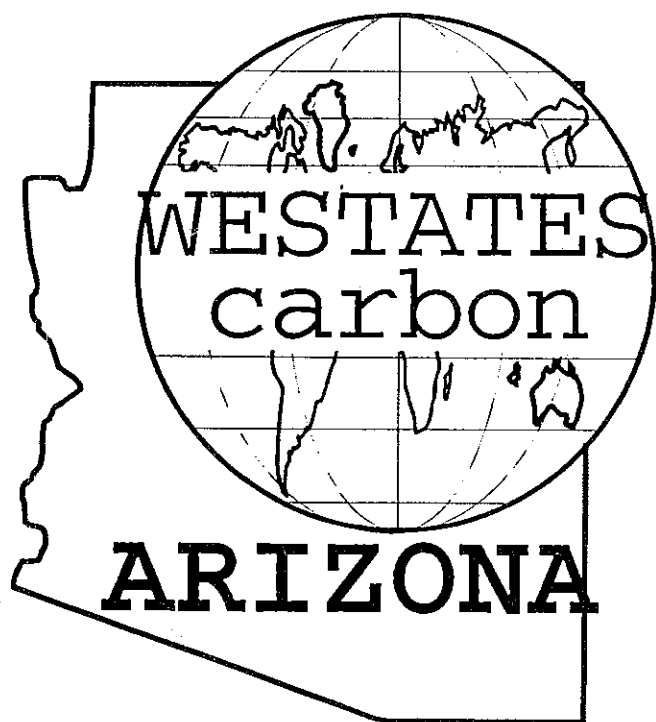REVISED RCRA
PART A
PERMIT APPLICATION

FOR

WESTATES CARBON - ARIZONA, INC.

PARKER REACTIVATION FACILITY

PARKER, ARIZONA

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1.0 INTRODUCTION

WCAI is submitting a revised Part A permit application to reflect current facility operations.

Revisions include the following.

1. Revision of the process flow diagram (Drawing No. 11135-002) to reflect recent facility modifications.
 - a. Addition of existing overflow lines, from spent carbon storage tanks (T-1, T-2, T-5, and T-6) to Recycle Water Tank (T-12), to the process flow diagram (Drawing No. 11135-002). These overflow lines were installed during the initial construction of the facility, but were inadvertently omitted from the process flow diagram.
 - b. Proposed addition of a water treatment system for recycle water as part of the facility's exempt wastewater treatment system. This system constitutes a wastewater treatment unit that is exempt from the requirements of Parts 264 and 265 in accordance with 40 CFR Part 264, §264.1(g)(6) and 40 CFR Part 265, §265.1(c)(10).
 - c. Proposed addition of a third spent carbon feed hopper.
2. The reference to the process flow diagram number on page 3 of 7 (Section XI) of the Part A application form and the Index Attachments found at Tab 5 have been corrected to read 11135-002.
3. Revision of the general facility layout to indicate the change in designation of some of the equipment. While the function of the equipment has not changed, the new designations better describe their functions. The new designations are listed in Table 1.

The redesignation of the Rainwater Collection Tank reflects the fact that rainwater collected in the tank is used as recycle water.
4. Submittal of a current photograph of Reactivation Unit No. 1 (RF-1), identified as Process Code T04 on page 4 of 7 (Section XII) of the Part A application form. The photograph is included in Attachment D (Tab 7).

TABLE 1	
Old Designation	Current Designation
Carbon Regeneration Unit No. 1 (CRU-1)	Carbon Reactivation Unit No. 1 (RF-1)
Carbon Regeneration Unit No. 1 (CRU-2)	Carbon Reactivation Unit No. 2 (RF-2)
Water Storage Tank (T-9)	Recycle Water Storage Tank (T-9)
Rainwater Collection Tank (T-12)	Recycle Water Storage Tank (T-12)
Industrial Sewer Surge Tank (T-11)	Equalization Tank (T-11)
Process Feed Tank (T-1)	Spent Carbon Storage Tank (T-1)
Process Feed Tank (T-2)	Spent Carbon Storage Tank (T-2)
Process Feed Tank (T-5)	Spent Carbon Storage Tank (T-5)
Process Feed Tank (T-6)	Spent Carbon Storage Tank (T-6)
Process Feed Tank (T-8)	Reactivation Unit No. 1 Feed Tank (T-8)

For EPA Regional Use Only		EPA		For State Use Only	
		United States Environmental Protection Agency Washington, DC 20460			
		Hazardous Waste Permit Application Part A			
Date Received		(Read the Instructions before starting)			
Month	Day	Year			
I. ID Number(s)					
A. EPA ID Number			B. Secondary ID Number (if applicable)		
A	Z	D	9	8	2
4	4	1	2	6	3
II. Name of Facility					
W	E	S	T	A	T
E	S		C	A	R
B	O	N	-	A	R
I	Z	O	N	A	I
N	C	.			
III. Facility Location (Physical address not P.O. Box or Route Number)					
A. Street					
2	5	2	3		
M	U	T	A	H	A
R	S	T	R	E	E
T					
Street (continued)					
City or Town					
P	A	R	K	E	R
State			ZIP Code		
A	Z	8	5	3	4
4	4	-	4	0	0
5					
County Code (if known)		County Name			
		L	A	P	A
		Z			
B. Land Type		C. Geographic Location		D. Facility Existence Date	
(enter code)	LATITUDE (degrees, minutes, & seconds)		LONGITUDE (degrees, minutes, & seconds)		Month
I	3	4	0	7	5
5	0	N	1	1	4
1	6	2	2	W	0
					8
					0
					5
					9
					1
IV. Facility Mailing Address					
Street or P. O. Box					
P	O	B	O	X	E
City or Town			State		ZIP Code
P	A	R	K	E	R
A	Z	8	5	3	4
4	4	-	4	0	0
5					
V. Facility Contact (Person to be contacted regarding waste activities at facility)					
Name (last)			Name (first)		
M	C	C	U	E	
Job Title			Phone Number (area code and number)		
P	L	A	N	T	
M	A	N	A	G	E
R					
6	0	2	-	6	6
9	-	5	7	5	8
VI. Facility Contact Address (See Instructions)					
Contract Address		B. Street or P. O. Box			
Location	Mailing				
	X				
City or Town			State		ZIP Code

Please print or type with ELITE type (12 characters per inch) in the unshaded areas only

EPA I.D. Number (enter from page 1)												Secondary ID Number (enter from page 1)											
A Z D 9 8 2 4 4 1 2 6 3																							
VII. Operator Information (see Instructions)																							
Name of Operator																							
W E S T A T E S C A R B O N - A R I Z O N A I N C .																							
Street or P.O. Box																							
2 5 2 3 M U T A H A R S T R E E T																							
City or Town												State				Zip Code							
P A R K E R												A Z				8 5 3 4 4 - 4 0 0 5							
Phone Number (area code and number)												B. Operator Type				Change of Operator				Date Changed			
6 0 2 - 6 6 9 - 5 7 5 8												P				Indicator				Month Day Year			
												Yes				No				X			
VIII. Facility Owner (see Instructions)																							
A. Name of Facility's Legal Owner																							
S E E A T T A C H M E N T A																							
Street or P.O. Box																							
City or Town												State				Zip Code							
																-							
Phone Number (area code and number)												B. Owner Type				Change of Owner				Date Changed			
																Indicator				Month Day Year			
												Yes				No							
IX. SIC Codes (4-digit, in order of significance)																							
Primary												Secondary											
4 9 5 3 (description)												9 9 9 9 (description) OTHERWISE											
REFUSE SYSTEMS												UNCLASSIFIABLE ESTABLISHMENTS											
Primary												Secondary											
(description)												(description)											
X. Other Environmental Permits (see Instructions)																							
A. Permit Type (enter code)				B. Permit Number												C. Description							
E				1 0 0 1 - 9 3												Municipal Indust. Sewer Dischg. Permit							
P				E X E M P T												PSD Permit (Minor Source)							
E				B 1 1 2 2 - C R 3 0. 7												CRIT BUSINESS LEASE							

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EPA I.D. Number (enter from page 1)												Secondary ID Number (enter from page 1)											
A	Z	D	9	8	2	4	4	1	2	6	3												

XI. Nature of Business (provide a brief description)

Westates Carbon-Arizona, Inc. receives spent (used) activated carbon from its customers. These spent carbons arrive at the Parker facility in a variety of DOT approved containers; including: barrels, drums, portable tanks, bulk-bags, and bulk truck units. Some, but not all, spent carbons are received as manifested hazardous waste materials.

Received spent carbons are thermally reactivated in one of two furnaces. Reactivated carbons are certified non-hazardous and then shipped for recycling and/or reuse. This reactivation process is sketched in a Schematic Block Process Flow Diagram attached as Drawing No. 11135-002.

Incidental to the reactivation process is the management of container storage (area S01); spent carbon storage tanks (area S02); reactivation and reactivation off-gas treatment (area T04); and the non-hazardous slurry transfer water (recycle water) system, wastewater treatment system, rainwater collection system, and reactivated carbon product storage and shipping.

XII. Process - Codes and Design Capacities

- A. PROCESS CODE - Enter the code from the list of process codes below that best describes each process to be used at the facility. Twelve lines are provided for entering codes. If more lines are needed, attach a separate sheet of paper with the additional information. If a process will be used that is not included in the list of codes below, then describe the process (including its design capacity) in the space provided in Item XIII.
- B. PROCESS DESIGN CAPACITY - For each code entered in column A, enter the capacity of the process.
1. AMOUNT - Enter the amount. In a case where design capacity is not applicable (such as in a closure/post-closure or enforcement action) enter the total amount of waste for that process unit.
 2. UNIT OF MEASURE - For each amount entered in column B(1), enter the code from the list of unit measure codes below that describes the unit of measure used. Only the units of measure that are listed below should be used.
- C. PROCESS TOTAL NUMBER OF UNITS - Enter the total number of units used with the corresponding process code.

PROCESS CODE	PROCESS	APPROPRIATE UNITS OF MEASURE FOR PROCESS DESIGN CAPACITY	UNIT OF MEASURE	
			UNIT OF MEASURE	CODE
D79	DISPOSAL:		GALLONS	G
	INJECTION WELL	GALLONS; LITERS; GALLONS PER DAY; OR LITERS PER DAY	GALLONS PER HOUR	E
			GALLONS PER DAY	U
			LITERS	L
			LITERS PER HOUR	H
D80	LANDFILL	ACRE-FEET OR HECTARE-METER	LITERS PER DAY	V
D81	LAND APPLICATION	ACRES OR HECTARES	SHORT TONS PER HOUR	D
D82	OCEAN DISPOSAL	GALLONS PER DAY OR LITERS PER DAY	METRIC TONS PER HOUR	W
D83	SURFACE IMPOUNDMENT	GALLONS OR LITERS	SHORT TONS PER DAY	N
S01	STORAGE:		METRIC TONS PER DAY	S
	CONTAINER	GALLONS OR LITERS	POUNDS PER HOUR	J
	(barrel, drum, etc.)		KILOGRAMS PER HOUR	R
	TANK	GALLONS OR LITERS	CUBIC YARDS	Y
	WASTE PILE	CUBIC YARDS OR CUBIC METERS	CUBIC METERS	C
S04	SURFACE IMPOUNDMENT	GALLONS OR LITERS	ACRES	B
T01	TREATMENT:		ACRE-FEET	A
	TANK	GALLONS PER DAY OR LITERS PER DAY	HECTARES	Q
	SURFACE IMPOUNDMENT	GALLONS PER DAY OR LITERS PER DAY	HECTARE-METER	F
	INCINERATOR	SHORT TONS PER HOUR; METRIC TONS PER HOUR; GALLONS PER HOUR; LITERS PER HOUR; OR BTUS PER HOUR	BTUS PER HOUR	K
T04	OTHER TREATMENT	GALLONS PER DAY; LITERS PER DAY; POUNDS PER HOUR; SHORT TONS PER HOUR; KILOGRAMS PER HOUR; METRIC TONS PER DAY; METRIC TONS PER HOUR; OR SHORT TONS PER DAY		
	(Use for physical, chemical, thermal or biological treatment processes not occurring in tanks, surface impoundment or incinerators. Describe the processes in the space provided in Item XIII.)			

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GSA No. 0246-EPA-OT

EPA I.D. Number (enter from page 1)

Secondary ID Number (enter from page 1)

A Z D 9 8 2 4 4 1 2 6 3

XII. Process - Codes and Design Capacities (continued)

EXAMPLE FOR COMPLETING ITEM XII (shown in line numbers X-1 and X-2 below): A facility has two storage tanks, one tank can hold 200 gallons and the other can hold 400 gallons. The facility also has an incinerator that can burn up to 20 gallons per hour.

Line Number	A. PROCESS		B. PROCESS DESIGN CAPACITY		C. PROCESS						
	(from list)		CODE 1. AMOUNT (specify above)	2. UNIT OF MEASURE	TOTAL NUMBERS	FOR OFFICIAL USE ONLY	OF UNITS (enter code)				
X 1	S	0 2	600	G	0 0 2						
X 2	T	0 3	20	E	0 0 1						
1	S	0 1	200,000	G	0 0 2						
2	S	0 2	35,000	G	0 0 5						
3	I	0 4	4,140	J	0 0 2						
4											
5											
6											
7											
8											
9											
0											
1	1										
1	2										

NOTE: If you need to list more than 12 process codes, attach an additional sheet(s) with the information in the same format as above. Number the lines sequentially, taking into account any lines that will be used for additional treatment processes in Item XIII.

XIII. Additional Treatment Processes (follow instructions from Item XII)

Line Number	A. PROCESS CODE		B. TREATMENT PROCESS DESIGN CAPACITY		C. PROCESS TOTAL		D. DESCRIPTION OF PROCESS			
	(enter numbers in sequence with Item		1. AMOUNT (specify)	2. UNIT OF	OF UNITS	MEASURE (enter code)				
	T	0 4								
	T	0 4								
	T	0 4								
	T	0 4								

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GSA No. 0246-EPA-OT

EPA I.D. Number (enter from page 1)												Secondary ID Number (enter from page 1)											
A	Z	D	9	8	2	4	4	1	2	6	3												

XIV. Description of Hazardous Wastes

A. EPA HAZARDOUS WASTE NUMBER - Enter the four-digit number from 40 CFR, Part 261 Subpart D of each listed hazardous waste you will handle. For hazardous wastes which are not listed in 40 CFR, Part 261 Subpart D, enter the four-digit number(s) from 40 CFR, Part 261 Subpart C that describes the characteristics and/or the toxic contaminants of those hazardous wastes.

B. ESTIMATED ANNUAL QUANTITY - For each listed waste entered in column A estimate the quantity of that waste that will be handled on an annual basis. For each characteristic or toxic contaminant entered in column A estimate the total annual quantity of all the non-listed waste(s) that will be handled which possess that characteristic or contaminant.

C. UNIT OF MEASURE - For each quantity entered in column B enter the unit of measure code. Units of measure which must be used and the appropriate codes are:

ENGLISH UNIT OF MEASURE	CODE	METRIC UNIT OF MEASURE	CODE
POUNDS	P	KILOGRAMS	K
TONS	T	METRIC TONS	M

If facility records use any other unit of measure for quantity, the units of measure must be converted into one of the required units of measure taking into account the appropriate density or specific gravity of the waste.

D. PROCESSES**1. PROCESS CODES:**

For listed hazardous waste: For each listed hazardous entered in column A select the code(s) from the list of process codes contained in Item XII A. on page 3 to indicate how the waste will be stored, treated, and/or disposed of at the facility.

For non-listed hazardous waste: For each characteristic or toxic contaminant entered in column A select the code(s) from the list of process codes contained in Item XII A. on page 3 to indicate all the processes that will be used to store, treat, and/or dispose of all the non-listed hazardous wastes that processes that characteristic or toxic contaminant.

NOTE: THREE SPACES ARE PROVIDED FOR ENTERING PROCESS CODES. IF MORE ARE NEEDED:

- Enter the first two as described above.
- Enter "000" in the extreme right box of Item XIV-D(1).
- space provided on page 7, Item XIV-E, the line number and the additional code(s).

2. PROCESS DESCRIPTION: For each process that will be used, describe the process in the space provided on the form (D(2)).

NOTE: HAZARDOUS WASTES DESCRIBED BY MORE THAN ONE EPA HAZARDOUS WASTE NUMBER - Hazardous wastes that can be described by more than one EPA Hazardous Waste Number shall be described on the form as follows:

- Select one of the EPA Hazardous Waste Numbers and enter it in column A. On the same line complete columns B, C, and D by estimating the total annual quantity of the waste and describing all the processes to be used to treat, store, and/or dispose of the waste.
- line enter the other EPA Hazardous Waste Number that can be used to describe the waste. In column D(2) on that line enter "included with above" and make no other entries on that line.
- each EPA Hazardous Waste Number that can be used to describe the hazardous waste.

COMPLETING ITEM XIV (shown in line numbers X-1, X-2, X-3, and X-4 below) - A facility will treat and dispose of an pounds per year of chrome shavings from leather tanning and finishing operation. In addition, the facility will treat and non-listed wastes. Two wastes are corrosive only and there will be an estimated 200 pounds per year of each waste. is corrosive and ignitable and there will be an estimated 100 pounds per year of that waste. Treatment will be in an incinerator and disposal will be in a landfill.

Line Number	A. EPA HAZARD WASTE NO. (enter code)				B. ESTIMATED ANNUAL QUANTITY OF WASTE	C. UNIT OF MEASURE (enter)	D. PROCESS MEASURE											
	(1) PROCESS CODES (enter code)												(2) PROCESS DESCRIPTION (if a code is not entered in D(1))					
X 1	K	0	5	4	900	P	7	0	3	D	8	0						
X 2	D	0	0	2	400	P	7	0	3	D	8	0						
X 3	D	0	0	1	100	P	7	0	3	D	8	0						
X 4	D	0	0			2												

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EPA I.D. Number (enter from page 1)												Secondary ID Number (enter from page 1)											
A	Z	D	9	8	2	4	4	1	2	6	3												
XIV. Description of Hazardous Wastes (continued)																							
Line Number	A. EPA HAZARDOUS WASTE NO. (enter code)					B. ESTIMATED ANNUAL QUANTITY OF WASTE	(enter	D. PROCESSES															
								C. UNIT OF MEASURE										(2) PROCESS DESCRIPTION (if a code is not entered in D(1))					
								(1) PROCESS CODES (enter code)															
1	D	0	0	1		5,000	P	S	0	1	S	0	2	T	0	4							
2	D	0	0	4		5,000	P	S	0	1	S	0	2	T	0	4							
3	D	0	0	5		5,000	P	S	0	1	S	0	2	T	0	4							
4	D	0	0	6		5,000	P	S	0	1	S	0	2	T	0	4							
5	D	0	0	7		5,000	P	S	0	1	S	0	2	T	0	4							
6	D	0	0	8		5,000	P	S	0	1	S	0	2	T	0	4							
7	D	0	0	9		5,000	P	S	0	1	S	0	2	T	0	4							
8	D	0	1	0		5,000	P	S	0	1	S	0	2	T	0	4							
9	D	0	1	1		5,000	P	S	0	1	S	0	2	T	0	4							
10	D	0	1	2		5,000	P	S	0	1	S	0	2	T	0	4							
11	D	0	1	3		5,000	P	S	0	1	S	0	2	T	0	4							
12	D	0	1	4		5,000	P	S	0	1	S	0	2	T	0	4							
13	D	0	1	5		5,000	P	S	0	1	S	0	2	T	0	4							
14	D	0	1	6		5,000	P	S	0	1	S	0	2	T	0	4							
15	D	0	1	7		5,000	P	S	0	1	S	0	2	T	0	4							
16	D	0	1	8		500,000	P	S	0	1	S	0	2	T	0	4							
17	D	0	1	9		5,000	P	S	0	1	S	0	2	T	0	4							
18	D	0	2	0		5,000	P	S	0	1	S	0	2	T	0	4							
19	D	0	2	1		5,000	P	S	0	1	S	0	2	T	0	4							
20	D	0	2	2		100,000	P	S	0	1	S	0	2	T	0	4							
21	D	0	2	3		5,000	P	S	0	1	S	0	2	T	0	4							
22	D	0	2	4		5,000	P	S	0	1	S	0	2	T	0	4							
23	D	0	2	5		5,000	P	S	0	1	S	0	2	T	0	4							
24	D	0	2	6		5,000	P	S	0	1	S	0	2	T	0	4							
25	D	0	2	7		5,000	P	S	0	1	S	0	2	T	0	4							
26	D	0	2	8		50,000	P	S	0	1	S	0	2	T	0	4							
27	D	0	2	9		100,000	P	S	0	1	S	0	2	T	0	4							
28	D	0	3	0		5,000	P	S	0	1	S	0	2	T	0	4							
29	D	0	3	1		5,000	P	S	0	1	S	0	2	T	0	4							
30	D	0	3	2		5,000	P	S	0	1	S	0	2	T	0	4							
31	D	0	3	3		5,000	P	S	0	1	S	0	2	T	0	4							
32	D	0	3	4		5,000	P	S	0	1	S	0	2	T	0	4							
33	D	0	3	5		100,000	P	S	0	1	S	0	2	T	0	4							

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EPA I.D. Number (enter from page 1)												Secondary ID Number (enter from page 1)											
A	Z	D	9	8	2	4	4	1	2	6	3												
XIV. Description of Hazardous Wastes (continued)																							
Line Number	A. EPA HAZARDOUS WASTE NO. (enter code)					B. ESTIMATED ANNUAL QUANTITY OF WASTE	(enter	D. PROCESSES															
								C. UNIT OF MEASURE															
								(1) PROCESS CODES (enter code)										(2) PROCESS DESCRIPTION (if a code is not entered in D(1))					
1	D	0	3	6		5,000	P	S	0	1	S	0	2	T	0	4							
2	D	0	3	7		5,000	P	S	0	1	S	0	2	T	0	4							
3	D	0	3	8		5,000	P	S	0	1	S	0	2	T	0	4							
4	D	0	3	9		500,000	P	S	0	1	S	0	2	T	0	4							
5	D	0	4	0		500,000	P	S	0	1	S	0	2	T	0	4							
6	D	0	4	1		5,000	P	S	0	1	S	0	2	T	0	4							
7	D	0	4	2		5,000	P	S	0	1	S	0	2	T	0	4							
8	D	0	4	3		50,000	P	S	0	1	S	0	2	T	0	4							
9	F	0	0	1		2,000,000	P	S	0	1	S	0	2	T	0	4							
10	F	0	0	2		5,000	P	S	0	1	S	0	2	T	0	4							
11	F	0	0	3		1,500,000	P	S	0	1	S	0	2	T	0	4							
12	F	0	0	4		5,000	P	S	0	1	S	0	2	T	0	4							
13	F	0	0	5		1,500,000	P	S	0	1	S	0	2	T	0	4							
14	F	0	0	6		5,000	P	S	0	1	S	0	2	T	0	4							
15	F	0	1	2		5,000	P	S	0	1	S	0	2	T	0	4							
16	F	0	1	9		5,000	P	S	0	1	S	0	2	T	0	4							
17	F	0	2	5		5,000	P	S	0	1	S	0	2	T	0	4							
18	F	0	3	2		5,000	P	S	0	1	S	0	2	T	0	4							
19	F	0	3	5		5,000	P	S	0	1	S	0	2	T	0	4							
20	F	0	3	7		5,000	P	S	0	1	S	0	2	T	0	4							
21	F	0	3	8		5,000	P	S	0	1	S	0	2	T	0	4							
21	F	0	3	9		5,000	P	S	0	1	S	0	2	T	0	4							
23	K	0	0	1		5,000	P	S	0	1	S	0	2	T	0	4							
24	K	0	0	2		5,000	P	S	0	1	S	0	2	T	0	4							
25	K	0	0	3		5,000	P	S	0	1	S	0	2	T	0	4							
26	K	0	0	4		5,000	P	S	0	1	S	0	2	T	0	4							
27	K	0	0	5		5,000	P	S	0	1	S	0	2	T	0	4							
28	K	0	0	6		5,000	P	S	0	1	S	0	2	T	0	4							
29	K	0	0	7		5,000	P	S	0	1	S	0	2	T	0	4							
30	K	0	0	8		5,000	P	S	0	1	S	0	2	T	0	4							
31	K	0	0	9		5,000	P	S	0	1	S	0	2	T	0	4							
32	K	0	1	0		5,000	P	S	0	1	S	0	2	T	0	4							
33	K	0	1	4		5,000	P	S	0	1	S	0	2	T	0	4							

Please print or type with ELITE type (12 characters per inch) in the unshaded areas only

EPA I.D. Number (enter from page 1)												Secondary ID Number (enter from page 1)											
A	Z	D	9	8	2	4	4	1	2	6	3												
XIV. Description of Hazardous Wastes (continued)																							
Line Number	A. EPA HAZARDOUS WASTE NO. (enter code)				B. ESTIMATED ANNUAL QUANTITY OF WASTE	(enter code)	D. PROCESSES																
							C. UNIT OF MEASURE (1) PROCESS CODES (enter code)										(2) PROCESS DESCRIPTION (if a code is not entered in D(1))						
1	K	0	6	5	5,000	P	S	0	1	S	0	2	T	0	4								
2	K	0	6	6	5,000	P	S	0	1	S	0	2	T	0	4								
3	K	0	7	1	5,000	P	S	0	1	S	0	2	T	0	4								
4	K	0	7	3	5,000	P	S	0	1	S	0	2	T	0	4								
5	K	0	8	3	5,000	P	S	0	1	S	0	2	T	0	4								
6	K	0	8	4	5,000	P	S	0	1	S	0	2	T	0	4								
7	K	0	8	5	5,000	P	S	0	1	S	0	2	T	0	4								
8	K	0	8	6	5,000	P	S	0	1	S	0	2	T	0	4								
9	K	0	8	7	5,000	P	S	0	1	S	0	2	T	0	4								
10	K	0	8	8	5,000	P	S	0	1	S	0	2	T	0	4								
11	K	0	9	0	5,000	P	S	0	1	S	0	2	T	0	4								
12	K	0	9	1	5,000	P	S	0	1	S	0	2	T	0	4								
13	K	0	9	3	5,000	P	S	0	1	S	0	2	T	0	4								
14	K	0	9	4	5,000	P	S	0	1	S	0	2	T	0	4								
15	K	0	9	5	5,000	P	S	0	1	S	0	2	T	0	4								
16	K	0	9	6	5,000	P	S	0	1	S	0	2	T	0	4								
17	K	0	9	7	5,000	P	S	0	1	S	0	2	T	0	4								
18	K	0	9	8	5,000	P	S	0	1	S	0	2	T	0	4								
19	K	1	0	0	5,000	P	S	0	1	S	0	2	T	0	4								
20	K	1	0	1	5,000	P	S	0	1	S	0	2	T	0	4								
21	K	1	0	2	5,000	P	S	0	1	S	0	2	T	0	4								
22	K	1	0	3	5,000	P	S	0	1	S	0	2	T	0	4								
23	K	1	0	4	5,000	P	S	0	1	S	0	2	T	0	4								
24	K	1	0	5	5,000	P	S	0	1	S	0	2	T	0	4								
25	K	1	0	6	5,000	P	S	0	1	S	0	2	T	0	4								
26	K	1	1	2	5,000	P	S	0	1	S	0	2	T	0	4								
27	K	1	1	3	5,000	P	S	0	1	S	0	2	T	0	4								
28	K	1	1	4	5,000	P	S	0	1	S	0	2	T	0	4								
29	K	1	1	5	5,000	P	S	0	1	S	0	2	T	0	4								
30	K	1	1	6	5,000	P	S	0	1	S	0	2	T	0	4								
31	K	1	1	7	5,000	P	S	0	1	S	0	2	T	0	4								
32	K	1	1	8	5,000	P	S	0	1	S	0	2	T	0	4								
33	K	1	2	5	5,000	P	S	0	1	S	0	2	T	0	4								

Please print or type with ELITE type (12 characters per inch) in the unshaded areas only

EPA I.D. Number (enter from page 1)											Secondary ID Number (enter from page 1)										
A	Z	D	9	8	2	4	4	1	2	6	3										
XIV. Description of Hazardous Wastes (continued)																					
Line Number	A. EPA HAZARDOUS WASTE NO. (enter code)					B. ESTIMATED ANNUAL QUANTITY OF WASTE	(enter P	D. PROCESSES													
								C. UNIT OF MEASURE													
								(1) PROCESS CODES (enter code)										(2) PROCESS DESCRIPTION (if a code is not entered in D(1))			
1	K	0	1	5	5,000	P	S	0	1	S	0	2	T	0	4						
2	K	0	1	6	5,000	P	S	0	1	S	0	2	T	0	4						
3	K	0	1	7	5,000	P	S	0	1	S	0	2	T	0	4						
4	K	0	1	8	5,000	P	S	0	1	S	0	2	T	0	4						
5	K	0	1	9	5,000	P	S	0	1	S	0	2	T	0	4						
6	K	0	2	0	5,000	P	S	0	1	S	0	2	T	0	4						
7	K	0	2	2	5,000	P	S	0	1	S	0	2	T	0	4						
8	K	0	2	3	5,000	P	S	0	1	S	0	2	T	0	4						
9	K	0	2	4	5,000	P	S	0	1	S	0	2	T	0	4						
10	K	0	2	5	5,000	P	S	0	1	S	0	2	T	0	4						
11	K	0	2	6	5,000	P	S	0	1	S	0	2	T	0	4						
12	K	0	2	9	5,000	P	S	0	1	S	0	2	T	0	4						
13	K	0	3	0	5,000	P	S	0	1	S	0	2	T	0	4						
14	K	0	3	1	5,000	P	S	0	1	S	0	2	T	0	4						
15	K	0	3	2	5,000	P	S	0	1	S	0	2	T	0	4						
16	K	0	3	3	5,000	P	S	0	1	S	0	2	T	0	4						
17	K	0	3	4	5,000	P	S	0	1	S	0	2	T	0	4						
18	K	0	3	5	5,000	P	S	0	1	S	0	2	T	0	4						
19	K	0	3	6	5,000	P	S	0	1	S	0	2	T	0	4						
20	K	0	3	7	5,000	P	S	0	1	S	0	2	T	0	4						
21	K	0	3	8	5,000	P	S	0	1	S	0	2	T	0	4						
22	K	0	3	9	5,000	P	S	0	1	S	0	2	T	0	4						
23	K	0	4	0	5,000	P	S	0	1	S	0	2	T	0	4						
24	K	0	4	1	5,000	P	S	0	1	S	0	2	T	0	4						
25	K	0	4	2	5,000	P	S	0	1	S	0	2	T	0	4						
26	K	0	4	6	5,000	P	S	0	1	S	0	2	T	0	4						
27	K	0	4	8	5,000	P	S	0	1	S	0	2	T	0	4						
28	K	0	4	9	5,000	P	S	0	1	S	0	2	T	0	4						
29	K	0	5	0	5,000	P	S	0	1	S	0	2	T	0	4						
30	K	0	5	1	5,000	P	S	0	1	S	0	2	T	0	4						
31	K	0	5	2	5,000	P	S	0	1	S	0	2	T	0	4						
32	K	0	6	1	5,000	P	S	0	1	S	0	2	T	0	4						
33	K	0	6	4	5,000	P	S	0	1	S	0	2	T	0	4						

Please print or type with ELITE type (12 characters per inch) in the unshaded areas only

EPA I.D. Number (enter from page 1)												Secondary ID Number (enter from page 1)											
A	Z	D	9	8	2	4	4	1	2	6	3												
XIV. Description of Hazardous Wastes (continued)																							
Line Number	A. EPA HAZARDOUS WASTE NO. (enter code)					B. ESTIMATED ANNUAL QUANTITY OF WASTE	(enter code)	D. PROCESSES															
								C. UNIT OF MEASURE (1) PROCESS CODES (enter code)										(2) PROCESS DESCRIPTION (if a code is not entered in D(1))					
1	K	1	2	6		5,000	P	S	0	1	S	0	2	T	0	4							
2	P	0	0	1		5,000	P	S	0	1	S	0	2	T	0	4							
3	P	0	0	2		5,000	P	S	0	1	S	0	2	T	0	4							
4	P	0	0	3		5,000	P	S	0	1	S	0	2	T	0	4							
5	P	0	0	4		5,000	P	S	0	1	S	0	2	T	0	4							
6	P	0	0	5		5,000	P	S	0	1	S	0	2	T	0	4							
7	P	0	0	7		5,000	P	S	0	1	S	0	2	T	0	4							
8	P	0	0	8		5,000	P	S	0	1	S	0	2	T	0	4							
9	P	0	1	0		5,000	P	S	0	1	S	0	2	T	0	4							
10	P	0	1	1		5,000	P	S	0	1	S	0	2	T	0	4							
11	P	0	1	2		5,000	P	S	0	1	S	0	2	T	0	4							
12	P	0	1	3		5,000	P	S	0	1	S	0	2	T	0	4							
13	P	0	1	4		5,000	P	S	0	1	S	0	2	T	0	4							
14	P	0	1	5		5,000	P	S	0	1	S	0	2	T	0	4							
15	P	0	1	6		5,000	P	S	0	1	S	0	2	T	0	4							
16	P	0	1	7		5,000	P	S	0	1	S	0	2	T	0	4							
17	P	0	1	8		5,000	P	S	0	1	S	0	2	T	0	4							
18	P	0	2	0		5,000	P	S	0	1	S	0	2	T	0	4							
19	P	0	2	1		5,000	P	S	0	1	S	0	2	T	0	4							
20	P	0	2	2		5,000	P	S	0	1	S	0	2	T	0	4							
21	P	0	2	3		5,000	P	S	0	1	S	0	2	T	0	4							
22	P	0	2	4		5,000	P	S	0	1	S	0	2	T	0	4							
23	P	0	2	6		5,000	P	S	0	1	S	0	2	T	0	4							
24	P	0	2	7		5,000	P	S	0	1	S	0	2	T	0	4							
25	P	0	2	8		5,000	P	S	0	1	S	0	2	T	0	4							
26	P	0	2	9		5,000	P	S	0	1	S	0	2	T	0	4							
27	P	0	3	0		5,000	P	S	0	1	S	0	2	T	0	4							
28	P	0	3	1		5,000	P	S	0	1	S	0	2	T	0	4							
29	P	0	3	3		5,000	P	S	0	1	S	0	2	T	0	4							
30	P	0	3	4		5,000	P	S	0	1	S	0	2	T	0	4							
31	P	0	3	6		5,000	P	S	0	1	S	0	2	T	0	4							
32	P	0	3	7		5,000	P	S	0	1	S	0	2	T	0	4							
33	P	0	3	8		5,000	P	S	0	1	S	0	2	T	0	4							

Please print or type with ELITE type (12 characters per inch) in the unshaded areas only

EPA I.D. Number (enter from page 1)												Secondary ID Number (enter from page 1)											
A	Z	D	9	8	2	4	4	1	2	6	3												
XIV. Description of Hazardous Wastes (continued)																							
Line Number	A. EPA HAZARDOUS WASTE NO. (enter code)					B. ESTIMATED ANNUAL QUANTITY OF WASTE	(enter code)	D. PROCESSES															
								C. UNIT OF MEASURE (1) PROCESS CODES (enter code)										(2) PROCESS DESCRIPTION (if a code is not entered in D(1))					
1	P	0	3	9		5,000	P	S	0	1	S	0	2	T	0	4							
2	P	0	4	0		5,000	P	S	0	1	S	0	2	T	0	4							
3	P	0	4	1		5,000	P	S	0	1	S	0	2	T	0	4							
4	P	0	4	2		5,000	P	S	0	1	S	0	2	T	0	4							
5	P	0	4	3		5,000	P	S	0	1	S	0	2	T	0	4							
6	P	0	4	4		5,000	P	S	0	1	S	0	2	T	0	4							
7	P	0	4	5		5,000	P	S	0	1	S	0	2	T	0	4							
8	P	0	4	6		5,000	P	S	0	1	S	0	2	T	0	4							
9	P	0	4	7		5,000	P	S	0	1	S	0	2	T	0	4							
10	P	0	4	8		5,000	P	S	0	1	S	0	2	T	0	4							
11	P	0	4	9		5,000	P	S	0	1	S	0	2	T	0	4							
12	P	0	5	0		5,000	P	S	0	1	S	0	2	T	0	4							
13	P	0	5	1		5,000	P	S	0	1	S	0	2	T	0	4							
14	P	0	5	4		5,000	P	S	0	1	S	0	2	T	0	4							
15	P	0	5	6		5,000	P	S	0	1	S	0	2	T	0	4							
16	P	0	5	7		5,000	P	S	0	1	S	0	2	T	0	4							
17	P	0	5	8		5,000	P	S	0	1	S	0	2	T	0	4							
18	P	0	5	9		5,000	P	S	0	1	S	0	2	T	0	4							
19	P	0	6	0		5,000	P	S	0	1	S	0	2	T	0	4							
20	P	0	6	2		5,000	P	S	0	1	S	0	2	T	0	4							
21	P	0	6	3		5,000	P	S	0	1	S	0	2	T	0	4							
22	P	0	6	4		5,000	P	S	0	1	S	0	2	T	0	4							
23	P	0	6	6		5,000	P	S	0	1	S	0	2	T	0	4							
24	P	0	6	7		5,000	P	S	0	1	S	0	2	T	0	4							
25	P	0	6	8		5,000	P	S	0	1	S	0	2	T	0	4							
26	P	0	6	9		5,000	P	S	0	1	S	0	2	T	0	4							
27	P	0	7	0		5,000	P	S	0	1	S	0	2	T	0	4							
28	P	0	7	1		5,000	P	S	0	1	S	0	2	T	0	4							
29	P	0	7	2		5,000	P	S	0	1	S	0	2	T	0	4							
30	P	0	7	3		5,000	P	S	0	1	S	0	2	T	0	4							
31	P	0	7	4		5,000	P	S	0	1	S	0	2	T	0	4							
32	P	0	7	5		5,000	P	S	0	1	S	0	2	T	0	4							
33	P	0	7	7		5,000	P	S	0	1	S	0	2	T	0	4							

Please print or type with ELITE type (12 characters per inch) in the unshaded areas only

EPA I.D. Number (enter from page 1)												Secondary ID Number (enter from page 1)											
A	Z	D	9	8	2	4	4	1	2	6	3												
XIV. Description of Hazardous Wastes (continued)																							
Line Number	A. EPA HAZARDOUS WASTE NO. (enter code)				B. ESTIMATED ANNUAL QUANTITY OF WASTE	(enter	D. PROCESSES																
							C. UNIT OF MEASURE										(2) PROCESS DESCRIPTION (if a code is not entered in D(1))						
						(1) PROCESS CODES (enter code)																	
1	P	0	7	8	5,000	P	S	0	1	S	0	2	T	0	4								
2	P	0	8	2	5,000	P	S	0	1	S	0	2	T	0	4								
3	P	0	8	4	5,000	P	S	0	1	S	0	2	T	0	4								
4	P	0	8	5	5,000	P	S	0	1	S	0	2	T	0	4								
5	P	0	8	7	5,000	P	S	0	1	S	0	2	T	0	4								
6	P	0	8	8	5,000	P	S	0	1	S	0	2	T	0	4								
7	P	0	8	9	5,000	P	S	0	1	S	0	2	T	0	4								
8	P	0	9	2	5,000	P	S	0	1	S	0	2	T	0	4								
9	P	0	9	3	5,000	P	S	0	1	S	0	2	T	0	4								
10	P	0	9	4	5,000	P	S	0	1	S	0	2	T	0	4								
11	P	0	9	5	5,000	P	S	0	1	S	0	2	T	0	4								
12	P	0	9	6	5,000	P	S	0	1	S	0	2	T	0	4								
13	P	0	9	7	5,000	P	S	0	1	S	0	2	T	0	4								
14	P	0	9	8	5,000	P	S	0	1	S	0	2	T	0	4								
15	P	0	9	9	5,000	P	S	0	1	S	0	2	T	0	4								
16	P	1	0	1	5,000	P	S	0	1	S	0	2	T	0	4								
17	P	1	0	2	5,000	P	S	0	1	S	0	2	T	0	4								
18	P	1	0	3	5,000	P	S	0	1	S	0	2	T	0	4								
19	P	1	0	4	5,000	P	S	0	1	S	0	2	T	0	4								
20	P	1	0	5	5,000	P	S	0	1	S	0	2	T	0	4								
21	P	1	0	6	5,000	P	S	0	1	S	0	2	T	0	4								
22	P	1	0	8	5,000	P	S	0	1	S	0	2	T	0	4								
23	P	1	0	9	5,000	P	S	0	1	S	0	2	T	0	4								
24	P	1	1	0	5,000	P	S	0	1	S	0	2	T	0	4								
25	P	1	1	3	5,000	P	S	0	1	S	0	2	T	0	4								
26	P	1	1	4	5,000	P	S	0	1	S	0	2	T	0	4								
27	P	1	1	5	5,000	P	S	0	1	S	0	2	T	0	4								
28	P	1	1	6	5,000	P	S	0	1	S	0	2	T	0	4								
29	P	1	1	8	5,000	P	S	0	1	S	0	2	T	0	4								
30	P	1	1	9	5,000	P	S	0	1	S	0	2	T	0	4								
31	P	1	2	0	5,000	P	S	0	1	S	0	2	T	0	4								
32	P	1	2	1	5,000	P	S	0	1	S	0	2	T	0	4								
33	P	1	2	3	5,000	P	S	0	1	S	0	2	T	0	4								

Please print or type with ELITE type (12 characters per inch) in the unshaded areas only

EPA I.D. Number (enter from page 1)											Secondary ID Number (enter from page 1)										
A	Z	D	9	8	2	4	4	1	2	6	3										
XIV. Description of Hazardous Wastes (continued)																					
Line Number	A. EPA HAZARDOUS WASTE NO. (enter code)				B. ESTIMATED ANNUAL QUANTITY OF WASTE	(enter code)	D. PROCESSES														
							C. UNIT OF MEASURE											(2) PROCESS DESCRIPTION (if a code is not entered in D(1))			
							(1) PROCESS CODES (enter code)														
1	U	0	0	1	5,000	P	S	0	1	S	0	2	T	0	4						
2	U	0	0	2	5,000	P	S	0	1	S	0	2	T	0	4						
3	U	0	0	3	5,000	P	S	0	1	S	0	2	T	0	4						
4	U	0	0	4	5,000	P	S	0	1	S	0	2	T	0	4						
5	U	0	0	5	5,000	P	S	0	1	S	0	2	T	0	4						
6	U	0	0	7	5,000	P	S	0	1	S	0	2	T	0	4						
7	U	0	0	8	5,000	P	S	0	1	S	0	2	T	0	4						
8	U	0	0	9	5,000	P	S	0	1	S	0	2	T	0	4						
9	U	0	1	0	5,000	P	S	0	1	S	0	2	T	0	4						
10	U	0	1	1	5,000	P	S	0	1	S	0	2	T	0	4						
11	U	0	1	2	5,000	P	S	0	1	S	0	2	T	0	4						
12	U	0	1	4	5,000	P	S	0	1	S	0	2	T	0	4						
13	U	0	1	5	5,000	P	S	0	1	S	0	2	T	0	4						
14	U	0	1	6	5,000	P	S	0	1	S	0	2	T	0	4						
15	U	0	1	7	5,000	P	S	0	1	S	0	2	T	0	4						
16	U	0	1	8	5,000	P	S	0	1	S	0	2	T	0	4						
17	U	0	1	9	5,000	P	S	0	1	S	0	2	T	0	4						
18	U	0	2	1	5,000	P	S	0	1	S	0	2	T	0	4						
19	U	0	2	2	5,000	P	S	0	1	S	0	2	T	0	4						
20	U	0	2	4	5,000	P	S	0	1	S	0	2	T	0	4						
21	U	0	2	5	5,000	P	S	0	1	S	0	2	T	0	4						
22	U	0	2	6	5,000	P	S	0	1	S	0	2	T	0	4						
23	U	0	2	7	5,000	P	S	0	1	S	0	2	T	0	4						
24	U	0	2	8	5,000	P	S	0	1	S	0	2	T	0	4						
25	U	0	2	9	5,000	P	S	0	1	S	0	2	T	0	4						
26	U	0	3	0	5,000	P	S	0	1	S	0	2	T	0	4						
27	U	0	3	1	5,000	P	S	0	1	S	0	2	T	0	4						
28	U	0	3	2	5,000	P	S	0	1	S	0	2	T	0	4						
29	U	0	3	4	5,000	P	S	0	1	S	0	2	T	0	4						
30	U	0	3	5	5,000	P	S	0	1	S	0	2	T	0	4						
31	U	0	3	6	5,000	P	S	0	1	S	0	2	T	0	4						
32	U	0	3	7	5,000	P	S	0	1	S	0	2	T	0	4						
33	U	0	3	8	5,000	P	S	0	1	S	0	2	T	0	4						

Please print or type with ELITE type (12 characters per inch) in the unshaded areas only

EPA I.D. Number (enter from page 1)												Secondary ID Number (enter from page 1)											
A	Z	D	9	8	2	4	4	1	2	6	3												
XIV. Description of Hazardous Wastes (continued)																							
Line Number	A. EPA HAZARDOUS WASTE NO. (enter code)				B. ESTIMATED ANNUAL QUANTITY OF WASTE	(enter code)	D. PROCESSES																
							C. UNIT OF MEASURE (1) PROCESS CODES (enter code)										(2) PROCESS DESCRIPTION (if a code is not entered in D(1))						
1	U	0	3	9	5,000	P	S	0	1	S	0	2	T	0	4								
2	U	0	4	1	5,000	P	S	0	1	S	0	2	T	0	4								
3	U	0	4	2	5,000	P	S	0	1	S	0	2	T	0	4								
4	U	0	4	3	5,000	P	S	0	1	S	0	2	T	0	4								
5	U	0	4	4	5,000	P	S	0	1	S	0	2	T	0	4								
6	U	0	4	5	5,000	P	S	0	1	S	0	2	T	0	4								
7	U	0	4	6	5,000	P	S	0	1	S	0	2	T	0	4								
8	U	0	4	7	5,000	P	S	0	1	S	0	2	T	0	4								
9	U	0	4	8	5,000	P	S	0	1	S	0	2	T	0	4								
10	U	0	4	9	5,000	P	S	0	1	S	0	2	T	0	4								
11	U	0	5	0	5,000	P	S	0	1	S	0	2	T	0	4								
12	U	0	5	1	5,000	P	S	0	1	S	0	2	T	0	4								
13	U	0	5	2	5,000	P	S	0	1	S	0	2	T	0	4								
14	U	0	5	3	5,000	P	S	0	1	S	0	2	T	0	4								
15	U	0	5	5	5,000	P	S	0	1	S	0	2	T	0	4								
16	U	0	5	6	5,000	P	S	0	1	S	0	2	T	0	4								
17	U	0	5	7	5,000	P	S	0	1	S	0	2	T	0	4								
18	U	0	5	8	5,000	P	S	0	1	S	0	2	T	0	4								
19	U	0	5	9	5,000	P	S	0	1	S	0	2	T	0	4								
20	U	0	6	0	5,000	P	S	0	1	S	0	2	T	0	4								
21	U	0	6	1	5,000	P	S	0	1	S	0	2	T	0	4								
22	U	0	6	2	5,000	P	S	0	1	S	0	2	T	0	4								
23	U	0	6	3	5,000	P	S	0	1	S	0	2	T	0	4								
24	U	0	6	4	5,000	P	S	0	1	S	0	2	T	0	4								
25	U	0	6	6	5,000	P	S	0	1	S	0	2	T	0	4								
26	U	0	6	7	5,000	P	S	0	1	S	0	2	T	0	4								
27	U	0	6	8	5,000	P	S	0	1	S	0	2	T	0	4								
28	U	0	6	9	5,000	P	S	0	1	S	0	2	T	0	4								
29	U	0	7	0	5,000	P	S	0	1	S	0	2	T	0	4								
30	U	0	7	1	5,000	P	S	0	1	S	0	2	T	0	4								
31	U	0	7	2	5,000	P	S	0	1	S	0	2	T	0	4								
32	U	0	7	3	5,000	P	S	0	1	S	0	2	T	0	4								
33	U	0	7	4	5,000	P	S	0	1	S	0	2	T	0	4								

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EPA I.D. Number (enter from page 1)											Secondary ID Number (enter from page 1)										
A	Z	D	9	8	2	4	4	1	2	6	3										
XIV. Description of Hazardous Wastes (continued)																					
Line Number	A. EPA HAZARDOUS WASTE NO. (enter code)				B. ESTIMATED ANNUAL QUANTITY OF WASTE	(enter code)	D. PROCESSES														
							C. UNIT OF MEASURE (1) PROCESS CODES (enter code)										(2) PROCESS DESCRIPTION (if a code is not entered in D(1))				
1	U	0	7	5	5,000	P	S	0	1	S	0	2	T	0	4						
2	U	0	7	6	5,000	P	S	0	1	S	0	2	T	0	4						
3	U	0	7	7	5,000	P	S	0	1	S	0	2	T	0	4						
4	U	0	7	8	5,000	P	S	0	1	S	0	2	T	0	4						
5	U	0	7	9	5,000	P	S	0	1	S	0	2	T	0	4						
6	U	0	8	0	5,000	P	S	0	1	S	0	2	T	0	4						
7	U	0	8	1	5,000	P	S	0	1	S	0	2	T	0	4						
8	U	0	8	2	5,000	P	S	0	1	S	0	2	T	0	4						
9	U	0	8	3	5,000	P	S	0	1	S	0	2	T	0	4						
10	U	0	8	4	5,000	P	S	0	1	S	0	2	T	0	4						
11	U	0	8	5	5,000	P	S	0	1	S	0	2	T	0	4						
12	U	0	8	6	5,000	P	S	0	1	S	0	2	T	0	4						
13	U	0	8	7	5,000	P	S	0	1	S	0	2	T	0	4						
14	U	0	8	8	5,000	P	S	0	1	S	0	2	T	0	4						
15	U	0	8	9	5,000	P	S	0	1	S	0	2	T	0	4						
16	U	0	9	0	5,000	P	S	0	1	S	0	2	T	0	4						
17	U	0	9	1	5,000	P	S	0	1	S	0	2	T	0	4						
18	U	0	9	2	5,000	P	S	0	1	S	0	2	T	0	4						
19	U	0	9	3	5,000	P	S	0	1	S	0	2	T	0	4						
20	U	0	9	4	5,000	P	S	0	1	S	0	2	T	0	4						
21	U	0	9	5	5,000	P	S	0	1	S	0	2	T	0	4						
22	U	0	9	7	5,000	P	S	0	1	S	0	2	T	0	4						
23	U	0	9	8	5,000	P	S	0	1	S	0	2	T	0	4						
24	U	0	9	9	5,000	P	S	0	1	S	0	2	T	0	4						
25	U	1	0	1	5,000	P	S	0	1	S	0	2	T	0	4						
26	U	1	0	2	5,000	P	S	0	1	S	0	2	T	0	4						
27	U	1	0	3	5,000	P	S	0	1	S	0	2	T	0	4						
28	U	1	0	5	5,000	P	S	0	1	S	0	2	T	0	4						
29	U	1	0	6	5,000	P	S	0	1	S	0	2	T	0	4						
30	U	1	0	7	5,000	P	S	0	1	S	0	2	T	0	4						
31	U	1	0	8	5,000	P	S	0	1	S	0	2	T	0	4						
32	U	1	0	9	5,000	P	S	0	1	S	0	2	T	0	4						
33	U	1	1	0	5,000	P	S	0	1	S	0	2	T	0	4						

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EPA I.D. Number (enter from page 1)												Secondary ID Number (enter from page 1)											
A	Z	D	9	8	2	4	4	1	2	6	3												
XIV. Description of Hazardous Wastes (continued)																							
Line Number	A. EPA HAZARDOUS WASTE NO. (enter code)				B. ESTIMATED ANNUAL QUANTITY OF WASTE	(enter code)	D. PROCESSES																
							C. UNIT OF MEASURE (1) PROCESS CODES (enter code)										(2) PROCESS DESCRIPTION (if a code is not entered in D(1))						
1	U	1	1	1	5,000	P	S	0	1	S	0	2	T	0	4								
2	U	1	1	2	5,000	P	S	0	1	S	0	2	T	0	4								
3	U	1	1	3	5,000	P	S	0	1	S	0	2	T	0	4								
4	U	1	1	4	5,000	P	S	0	1	S	0	2	T	0	4								
5	U	1	1	5	5,000	P	S	0	1	S	0	2	T	0	4								
6	U	1	1	6	5,000	P	S	0	1	S	0	2	T	0	4								
7	U	1	1	7	5,000	P	S	0	1	S	0	2	T	0	4								
8	U	1	1	8	5,000	P	S	0	1	S	0	2	T	0	4								
9	U	1	1	9	5,000	P	S	0	1	S	0	2	T	0	4								
10	U	1	2	0	5,000	P	S	0	1	S	0	2	T	0	4								
11	U	1	2	1	5,000	P	S	0	1	S	0	2	T	0	4								
12	U	1	2	2	5,000	P	S	0	1	S	0	2	T	0	4								
13	U	1	2	4	5,000	P	S	0	1	S	0	2	T	0	4								
14	U	1	2	5	5,000	P	S	0	1	S	0	2	T	0	4								
15	U	1	2	6	5,000	P	S	0	1	S	0	2	T	0	4								
16	U	1	2	7	5,000	P	S	0	1	S	0	2	T	0	4								
17	U	1	2	8	5,000	P	S	0	1	S	0	2	T	0	4								
18	U	1	2	9	5,000	P	S	0	1	S	0	2	T	0	4								
19	U	1	3	0	5,000	P	S	0	1	S	0	2	T	0	4								
20	U	1	3	1	5,000	P	S	0	1	S	0	2	T	0	4								
21	U	1	3	2	5,000	P	S	0	1	S	0	2	T	0	4								
22	U	1	3	5	5,000	P	S	0	1	S	0	2	T	0	4								
23	U	1	3	6	5,000	P	S	0	1	S	0	2	T	0	4								
24	U	1	3	7	5,000	P	S	0	1	S	0	2	T	0	4								
25	U	1	3	8	5,000	P	S	0	1	S	0	2	T	0	4								
26	U	1	4	0	5,000	P	S	0	1	S	0	2	T	0	4								
27	U	1	4	1	5,000	P	S	0	1	S	0	2	T	0	4								
28	U	1	4	2	5,000	P	S	0	1	S	0	2	T	0	4								
29	U	1	4	3	5,000	P	S	0	1	S	0	2	T	0	4								
30	U	1	4	4	5,000	P	S	0	1	S	0	2	T	0	4								
31	U	1	4	5	5,000	P	S	0	1	S	0	2	T	0	4								
32	U	1	4	6	5,000	P	S	0	1	S	0	2	T	0	4								
33	U	1	4	7	5,000	P	S	0	1	S	0	2	T	0	4								

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EPA I.D. Number (enter from page 1)												Secondary ID Number (enter from page 1)											
A	Z	D	9	8	2	4	4	1	2	6	3												
XIV. Description of Hazardous Wastes (continued)																							
Line Number	A. EPA HAZARDOUS WASTE NO. (enter code)					B. ESTIMATED ANNUAL QUANTITY OF WASTE	(enter code)	D. PROCESSES															
								C. UNIT OF MEASURE (1) PROCESS CODES (enter code)										(2) PROCESS DESCRIPTION (if a code is not entered in D(1))					
1	U	1	4	8		5,000	P	S	0	1	S	0	2	T	0	4							
2	U	1	4	9		5,000	P	S	0	1	S	0	2	T	0	4							
3	U	1	5	0		5,000	P	S	0	1	S	0	2	T	0	4							
4	U	1	5	1		5,000	P	S	0	1	S	0	2	T	0	4							
5	U	1	5	2		5,000	P	S	0	1	S	0	2	T	0	4							
6	U	1	5	3		5,000	P	S	0	1	S	0	2	T	0	4							
7	U	1	5	4		5,000	P	S	0	1	S	0	2	T	0	4							
8	U	1	5	5		5,000	P	S	0	1	S	0	2	T	0	4							
9	U	1	5	6		5,000	P	S	0	1	S	0	2	T	0	4							
10	U	1	5	7		5,000	P	S	0	1	S	0	2	T	0	4							
11	U	1	5	8		5,000	P	S	0	1	S	0	2	T	0	4							
12	U	1	5	9		5,000	P	S	0	1	S	0	2	T	0	4							
13	U	1	6	1		5,000	P	S	0	1	S	0	2	T	0	4							
14	U	1	6	2		5,000	P	S	0	1	S	0	2	T	0	4							
15	U	1	6	3		5,000	P	S	0	1	S	0	2	T	0	4							
16	U	1	6	4		5,000	P	S	0	1	S	0	2	T	0	4							
17	U	1	6	5		5,000	P	S	0	1	S	0	2	T	0	4							
18	U	1	6	6		5,000	P	S	0	1	S	0	2	T	0	4							
19	U	1	6	7		5,000	P	S	0	1	S	0	2	T	0	4							
20	U	1	6	8		5,000	P	S	0	1	S	0	2	T	0	4							
21	U	1	6	9		5,000	P	S	0	1	S	0	2	T	0	4							
22	U	1	7	0		5,000	P	S	0	1	S	0	2	T	0	4							
23	U	1	7	1		5,000	P	S	0	1	S	0	2	T	0	4							
24	U	1	7	2		5,000	P	S	0	1	S	0	2	T	0	4							
25	U	1	7	3		5,000	P	S	0	1	S	0	2	T	0	4							
26	U	1	7	4		5,000	P	S	0	1	S	0	2	T	0	4							
27	U	1	7	6		5,000	P	S	0	1	S	0	2	T	0	4							
28	U	1	7	7		5,000	P	S	0	1	S	0	2	T	0	4							
29	U	1	7	8		5,000	P	S	0	1	S	0	2	T	0	4							
30	U	1	7	9		5,000	P	S	0	1	S	0	2	T	0	4							
31	U	1	8	0		5,000	P	S	0	1	S	0	2	T	0	4							
32	U	1	8	1		5,000	P	S	0	1	S	0	2	T	0	4							
33	U	1	8	2		5,000	P	S	0	1	S	0	2	T	0	4							

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EPA I.D. Number (enter from page 1)												Secondary ID Number (enter from page 1)											
A	Z	D	9	8	2	4	4	1	2	6	3												
XIV. Description of Hazardous Wastes (continued)																							
Line Number	A. EPA HAZARDOUS WASTE NO. (enter code)				B. ESTIMATED ANNUAL QUANTITY OF WASTE	(enter code)	D. PROCESSES																
							C. UNIT OF MEASURE (1) PROCESS CODES (enter code)										(2) PROCESS DESCRIPTION (if a code is not entered in D(1))						
1	U	1	8	3	5,000	P	S	0	1	S	0	2	T	0	4								
2	U	1	8	4	5,000	P	S	0	1	S	0	2	T	0	4								
3	U	1	8	5	5,000	P	S	0	1	S	0	2	T	0	4								
4	U	1	8	6	5,000	P	S	0	1	S	0	2	T	0	4								
5	U	1	8	7	5,000	P	S	0	1	S	0	2	T	0	4								
6	U	1	8	8	5,000	P	S	0	1	S	0	2	T	0	4								
7	U	1	9	0	5,000	P	S	0	1	S	0	2	T	0	4								
8	U	1	9	1	5,000	P	S	0	1	S	0	2	T	0	4								
9	U	1	9	2	5,000	P	S	0	1	S	0	2	T	0	4								
10	U	1	9	3	5,000	P	S	0	1	S	0	2	T	0	4								
11	U	1	9	4	5,000	P	S	0	1	S	0	2	T	0	4								
12	U	1	9	6	5,000	P	S	0	1	S	0	2	T	0	4								
13	U	1	9	7	5,000	P	S	0	1	S	0	2	T	0	4								
14	U	2	0	0	5,000	P	S	0	1	S	0	2	T	0	4								
15	U	2	0	1	5,000	P	S	0	1	S	0	2	T	0	4								
16	U	2	0	2	5,000	P	S	0	1	S	0	2	T	0	4								
17	U	2	0	3	5,000	P	S	0	1	S	0	2	T	0	4								
18	U	2	0	4	5,000	P	S	0	1	S	0	2	T	0	4								
19	U	2	0	6	5,000	P	S	0	1	S	0	2	T	0	4								
20	U	2	0	7	5,000	P	S	0	1	S	0	2	T	0	4								
21	U	2	0	8	5,000	P	S	0	1	S	0	2	T	0	4								
22	U	2	0	9	5,000	P	S	0	1	S	0	2	T	0	4								
23	U	2	1	0	5,000	P	S	0	1	S	0	2	T	0	4								
24	U	2	1	1	5,000	P	S	0	1	S	0	2	T	0	4								
25	U	2	1	3	5,000	P	S	0	1	S	0	2	T	0	4								
26	U	2	1	4	5,000	P	S	0	1	S	0	2	T	0	4								
27	U	2	1	5	5,000	P	S	0	1	S	0	2	T	0	4								
28	U	2	1	6	5,000	P	S	0	1	S	0	2	T	0	4								
29	U	2	1	7	5,000	P	S	0	1	S	0	2	T	0	4								
30	U	2	1	8	5,000	P	S	0	1	S	0	2	T	0	4								
31	U	2	1	9	5,000	P	S	0	1	S	0	2	T	0	4								
32	U	2	2	0	5,000	P	S	0	1	S	0	2	T	0	4								
33	U	2	2	1	5,000	P	S	0	1	S	0	2	T	0	4								

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EPA I.D. Number (enter from page 1)												Secondary ID Number (enter from page 1)											
A	Z	D	9	8	2	4	4	1	2	6	3												
XIV. Description of Hazardous Wastes (continued)																							
Line Number	A. EPA HAZARDOUS WASTE NO. (enter code)				B. ESTIMATED ANNUAL QUANTITY OF WASTE	(enter code)	D. PROCESSES																
							C. UNIT OF MEASURE (1) PROCESS CODES (enter code)										(2) PROCESS DESCRIPTION (if a code is not entered in D(1))						
1	U	2	2	2	5,000	P	S	0	1	S	0	2	T	0	4								
2	U	2	2	5	5,000	P	S	0	1	S	0	2	T	0	4								
3	U	2	2	6	5,000	P	S	0	1	S	0	2	T	0	4								
4	U	2	2	7	5,000	P	S	0	1	S	0	2	T	0	4								
5	U	2	2	8	5,000	P	S	0	1	S	0	2	T	0	4								
6	U	2	3	5	5,000	P	S	0	1	S	0	2	T	0	4								
7	U	2	3	6	5,000	P	S	0	1	S	0	2	T	0	4								
8	U	2	3	7	5,000	P	S	0	1	S	0	2	T	0	4								
9	U	2	3	8	5,000	P	S	0	1	S	0	2	T	0	4								
10	U	2	3	9	5,000	P	S	0	1	S	0	2	T	0	4								
11	U	2	4	0	5,000	P	S	0	1	S	0	2	T	0	4								
12	U	2	4	3	5,000	P	S	0	1	S	0	2	T	0	4								
13	U	2	4	4	5,000	P	S	0	1	S	0	2	T	0	4								
14	U	2	4	6	5,000	P	S	0	1	S	0	2	T	0	4								
15	U	2	4	7	5,000	P	S	0	1	S	0	2	T	0	4								
16	U	2	4	8	5,000	P	S	0	1	S	0	2	T	0	4								
17	U	2	4	9	5,000	P	S	0	1	S	0	2	T	0	4								
18	U	3	2	8	5,000	P	S	0	1	S	0	2	T	0	4								
19	U	3	5	3	5,000	P	S	0	1	S	0	2	T	0	4								
20	U	3	5	9	5,000	P	S	0	1	S	0	2	T	0	4								
21																							
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32																							
33																							

EPA ID Number (Enter from page 1)

A Z D 9 8 2 4 4 1 2 6 3

Secondary ID Number (Enter from page 1)

XV. Map

Attach to this application a topographic map, or other equivalent map, of the area extending to at least one mile beyond property boundaries. The map must show the outline of the facility, the location of each of its existing and proposed intake and discharge structures, each of its hazardous waste treatment, storage, or disposal facilities, and each well where it injects fluids underground. Include all springs, rivers and other surface water bodies in this map area. See instructions for precise requirements.

XVI. Facility Drawing

All existing facilities must include a scale drawing of the facility (see instructions for more detail).

XVII. Photographs

All existing facilities must include photographs (aerial or ground-level) that clearly delineate all existing structures; existing storage, treatment and disposal areas; and sites of future storage, treatment or disposal areas (see instructions for more detail).

XVIII. Certification(s)

I certify under penalty of law that this document and all attachments were prepared under my direction or supervision in accordance with a system designed to assure that qualified personnel properly gather and evaluate the information submitted. Based on my inquiry of the person or persons who manage the system, or those persons directly responsible for gathering the information, the information submitted is, to the best of my knowledge and belief, true, accurate, and complete. I am aware that there are significant penalties for submitting false information, including the possibility of fine and imprisonment for knowing violations.

Operator Signature *

Date Signed

Name and Official Title (Type or print)

Gregor E. Nordgaard, Vice President, U.S. Filter Recovery Services, Inc. (Facility Owner)

Owner Signature

Date Signed

Name and Official Title (Type or print)

Daniel Eddy, Jr., Chairman, Colorado River Indian Tribes (Property Owner)

Operator Signature

Date Signed

Name and Official Title (Type or print)

Operator Signature

Date Signed

Name and Official Title (Type or print)

XIX. Comments

Received spent carbons are thermally reactivated in one of two furnaces. Reactivated carbons are certified non-hazardous and then shipped for recycling and/or reuse. This reactivation process is sketched in a Schematic Block-Process Flow Diagram attached as Drawing No. 11135-002.

Incidental to the reactivation process is the management of container storage (area S01); spent carbon storage tanks (area S02); reactivation and reactivation off-gas treatment (area T04); and the non-hazardous slurry transfer water (recycle water) system, wastewater treatment system, rainwater collection system, and reactivated carbon product storage and shipping.

*(Footnote to Section XVIII) EPA currently has a Part A that is signed by Westates Carbon-Arizona, Inc. This Part A is signed on behalf of the company which has agreed to acquire the shares of Westates Carbon-Arizona, Inc.

Note: Mail completed form to the appropriate EPA Regional or State Office. (Refer to instructions for more information)

INDEX OF ATTACHMENTS

ATTACHMENTS

DESCRIPTION

- | | |
|---|---------------------------------------------------------------------------------------|
| A | ITEM VIII -- Facility Owner |
| B | ITEM XV -- Map |
| | 1. Drawing No. C-100604 Sheet 1 of 2 (Rev. 0)
Topographical Map 1 - Plant Site |
| | 2. Drawing No. C-100604 Sheet 2 of 2 (Rev. 0)
Topographical Map 2 - Adjacent Lands |
| C | ITEM XVI -- Facility Drawing |
| | 1. Scale Drawing of Property Layout |
| | 2. Scale Drawing of Facility Layout (Equipment Location) |
| | 3. Drawing No. 11135-002 (Rev. 1)
Schematic Process Flow Diagram |
| D | ITEM XVII -- Photographs |
| | 1. Site Photographs |
| | 2. Site Aerial Photograph |

ATTACHMENT A

ITEM VIII -- FACILITY OWNER

ADDITIONAL INFORMATION

EPA ID NUMBER: AZD982441263

ATTACHMENT A -- ITEM VIII

FACILITY OWNER

NAME OF FACILITY'S LEGAL OWNER

WESTATES CARBON-ARIZONA, INC.
2523 MUTAHAR STREET
PARKER, ARIZONA 85344-4005
TELEPHONE: 602-669-5758

OWNER TYPE - P

NAME OF PROPERTY OWNER:


COLORADO RIVER INDIAN TRIBES
RT - 1, BOX 23 - B
PARKER, ARIZONA - 85344
TELEPHONE: 602-669-9211

OWNER TYPE - I

ATTACHMENT B


ITEM XV -- MAP

1. DRAWING NO. C-100604 SHEET 1 OF 2 (REV. 0)
TOPOGRAPHICAL MAP 1 - PLANT SITE
2. DRAWING NO. C-100604 SHEET 2 OF 2 (REV. 0)
TOPOGRAPHICAL MAP 2 - ADJACENT LANDS

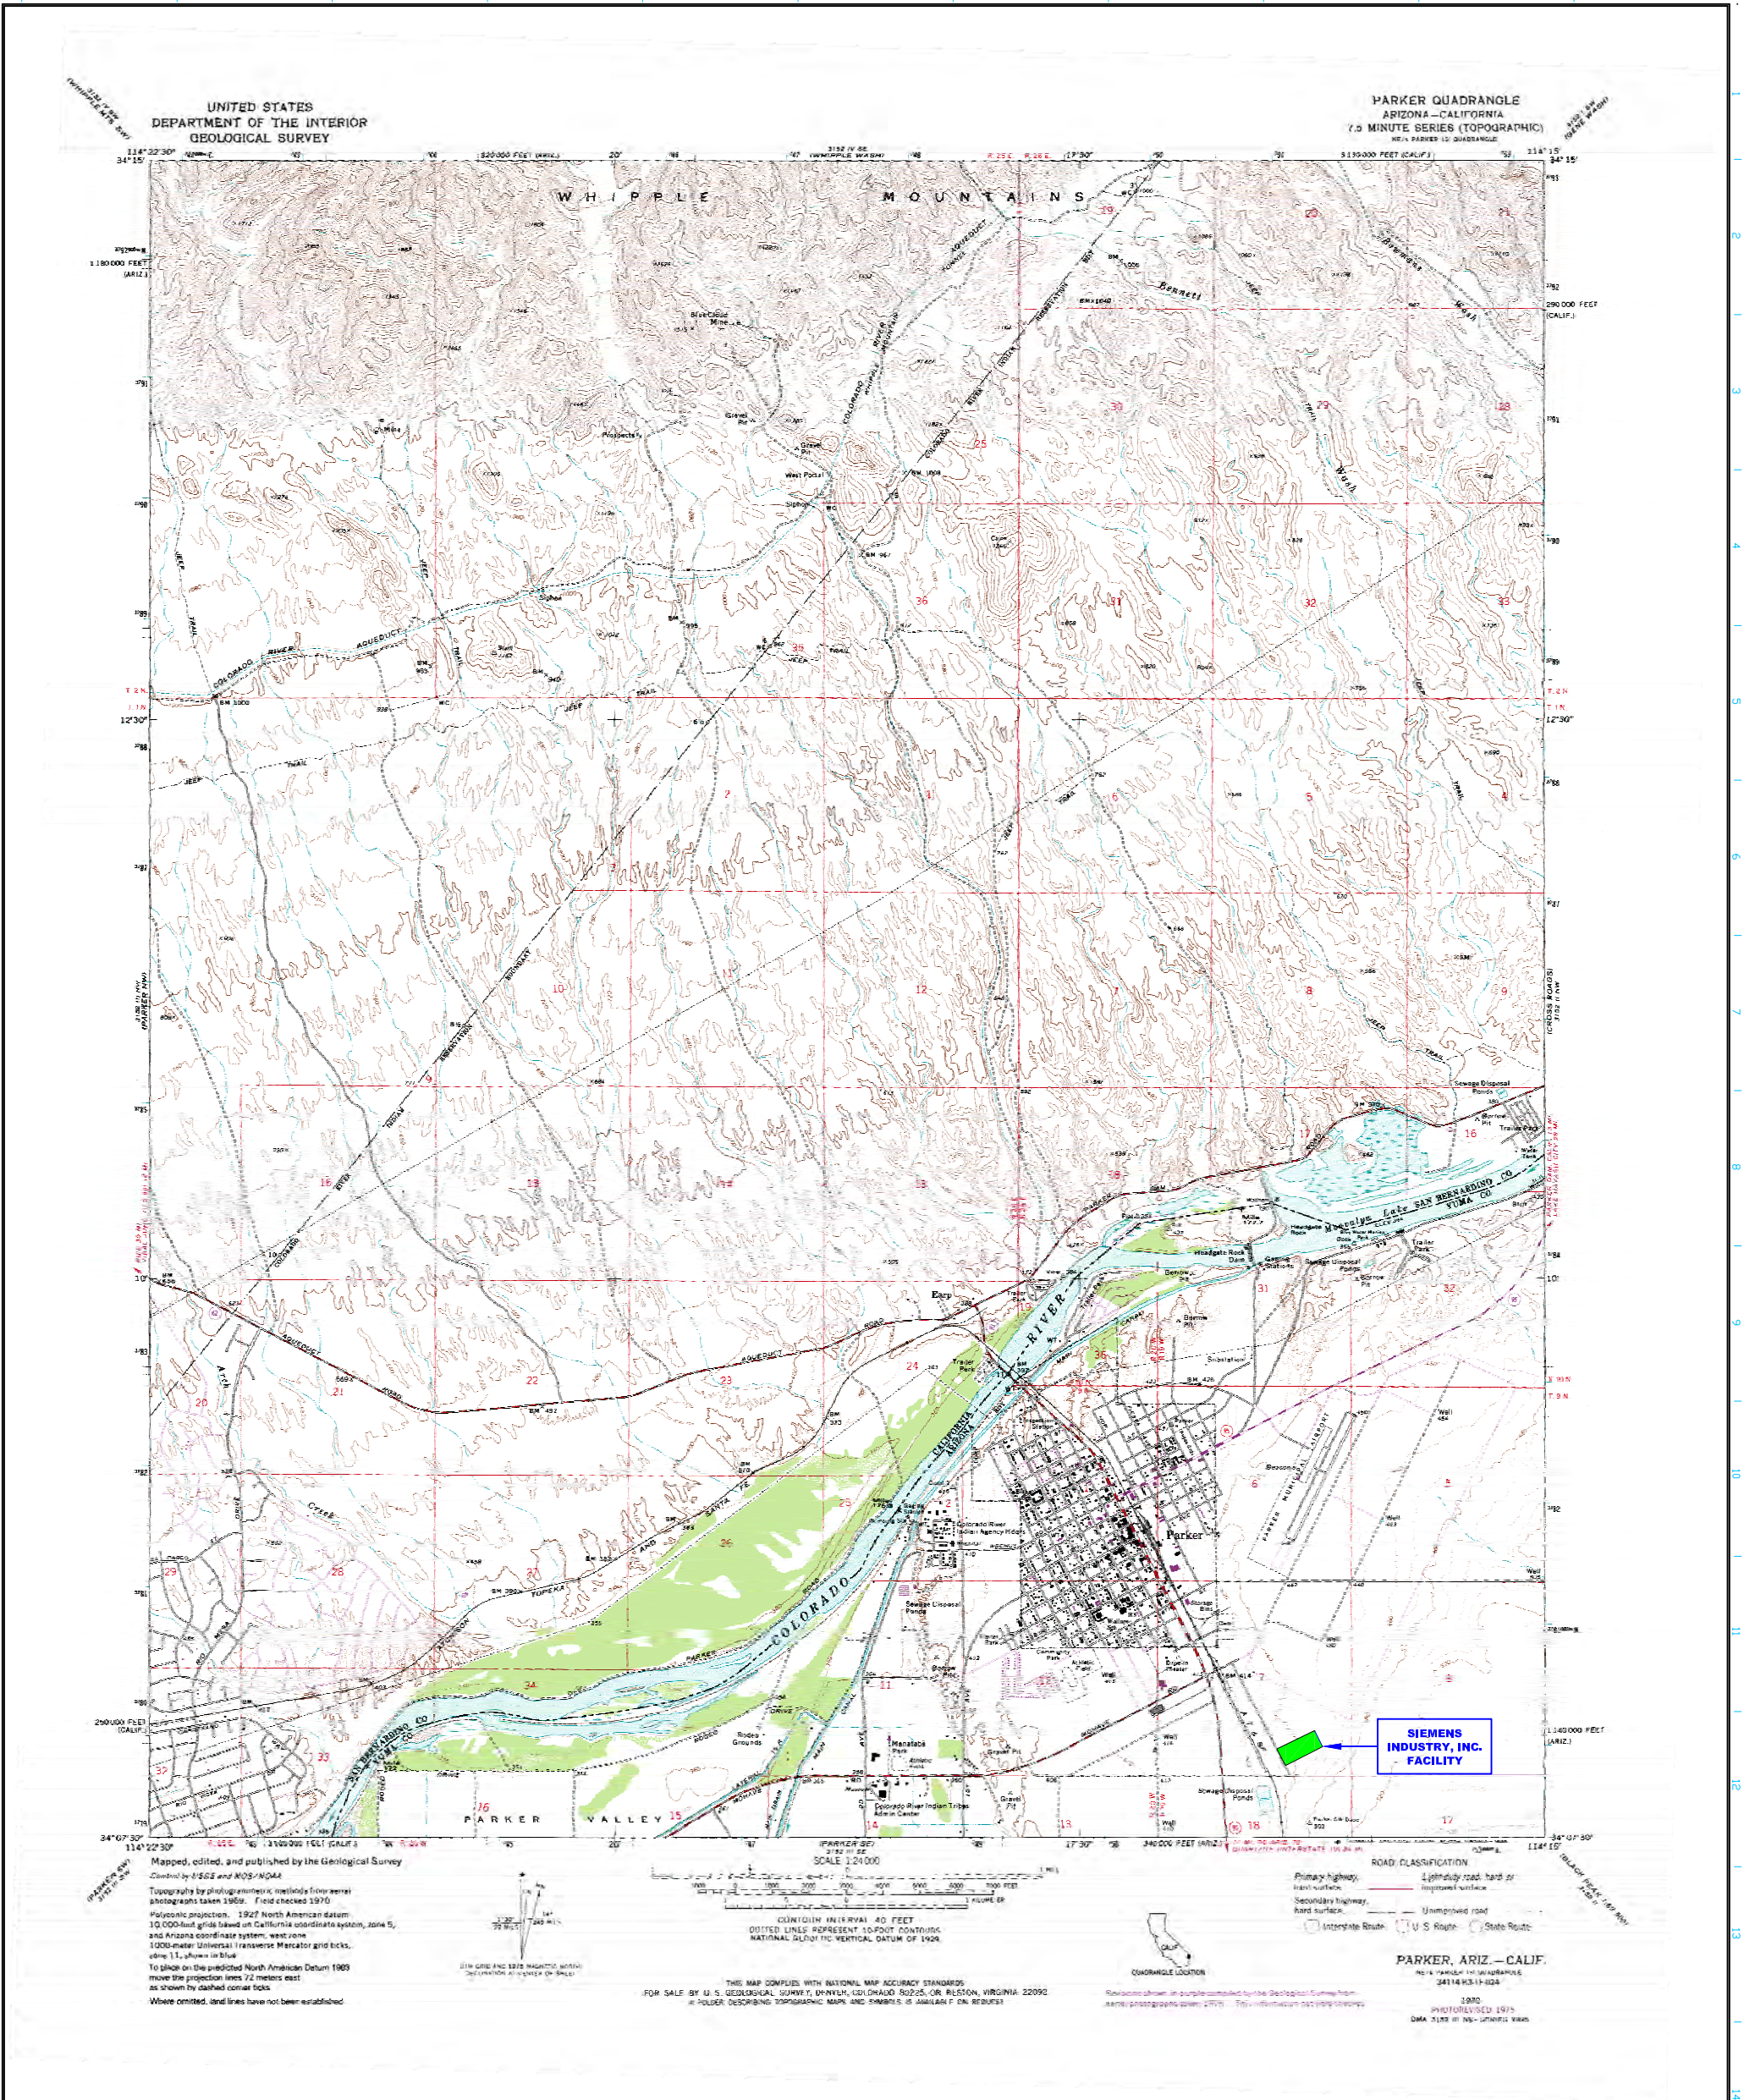

- NOTES:
1. SEE ATTACHED SIEMENS INDUSTRY, INC. DRAWING D-14789-02 FOR DETAILED LOCATION OF S01, S02, AND X03.
 2. THERE ARE NO INJECTION WELLS ASSOCIATED WITH THIS FACILITY.
 3. THERE ARE NO SPRINGS, DRINKING WATER WELLS, NOR SURFACE WATER BODIES LOCATED WITHIN 1/4 MILE OF THIS FACILITY.

					CUSTOMER: SIEMENS INDUSTRY, INC.		SIEMENS INDUSTRY, INC. Parker, AZ					
					LOCATION: 2523 MUTAHAR ST. PARKER, AZ 85344							
					PLOT SCALE: AS NOTED		TITLE: U.S.G.S. SURVEY - PARKER, AZ TOPOGRAPHIC MAP					
					DO NOT SCALE DRAWING							
					THIS DRAWING IS THE PROPERTY OF SIEMENS AND CANNOT BE REPRODUCED OR DELIVERED TO OTHERS WITHOUT THE EXPRESS WRITTEN PERMISSION OF SIEMENS INDUSTRY, INC.							
1	3/15/12	NAME CHANGED TO SIEMENS INDUSTRY, INC.	JBE	KEM			PROJECT No.					
					DRAWN: JBE		1/22/07					
					CHK'D: KEM		1/22/07					
					ENG'R:							
							DWG No. C-100604		SHEET No. 1 of 2		REV. 1	

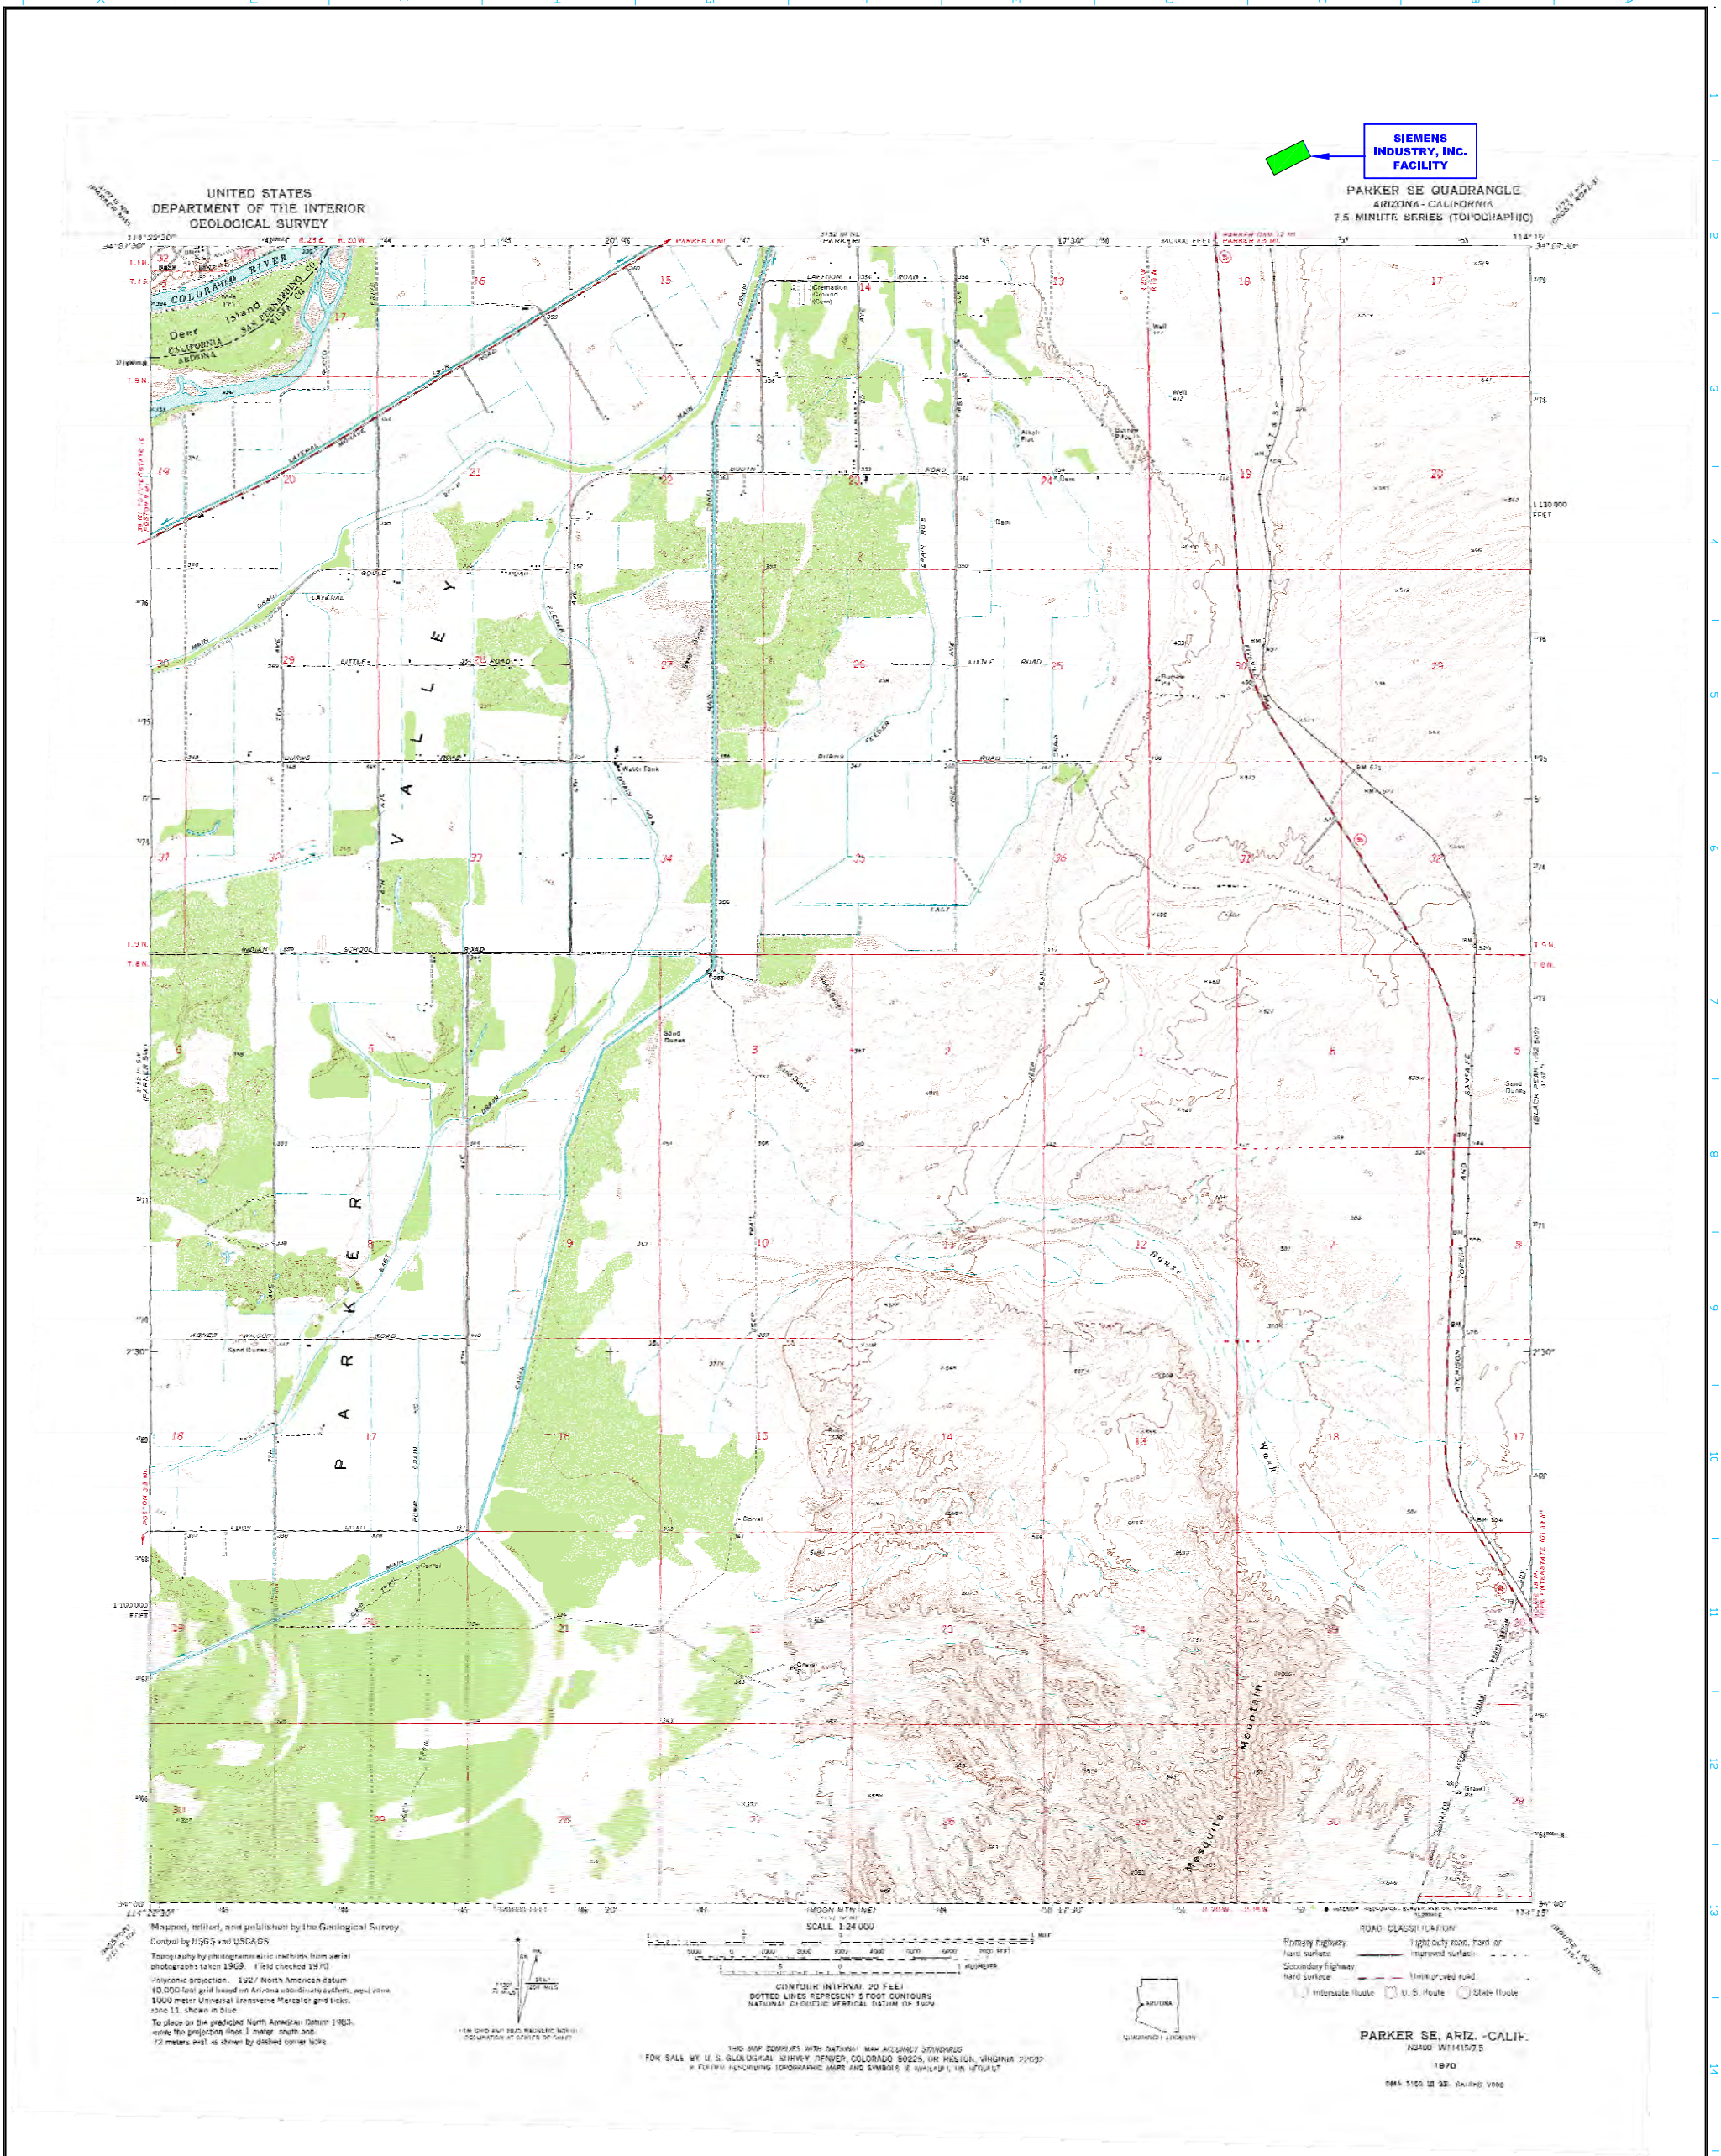

NOTES:


- SEE ATTACHED SIEMENS WATER TECHNOLOGIES CORP. DRAWING D-14789-02 FOR DETAILED LOCATION OF S01, S02, AND X03.
- THERE ARE NO INJECTION WELLS ASSOCIATED WITH THIS FACILITY.
- THERE ARE NO SPRINGS, DRINKING WATER WELLS, NOR SURFACE WATER BODIES LOCATED WITHIN 1/4 MILE OF THIS FACILITY.

1		3/15/12	NAME CHANGED TO SIEMENS INDUSTRY, INC.	JBE	KEM	THIS DRAWING IS THE PROPERTY OF SIEMENS AND CANNOT BE REPRODUCED OR DELIVERED TO OTHERS WITHOUT THE EXPRESS WRITTEN PERMISSION OF SIEMENS INDUSTRY, INC.	CUSTOMER: SIEMENS INDUSTRY, INC.		LOCATION: 2523 MUTAHAR ST. PARKER, AZ 85344	PROJECT No.	DRAWN: JBE 1/22/07	CHK'D: KEM 1/22/07	ENG'R:	DWG No. C-100604	SHEET No. 2 of 2	REV. 1
REV.	DATE	REVISION DESCRIPTION			DRAWN	CHK'D										

ATTACHMENT C

ITEM XVII -- FACILITY DRAWING

1. SCALE DRAWING OF PROPERTY LAYOUT
2. SCALE DRAWING OF FACILITY LAYOUT (EQUIPMENT LOCATION)
3. DRAWING NO. 11135-002 -- SCHEMATIC PROCESS FLOW DIAGRAM

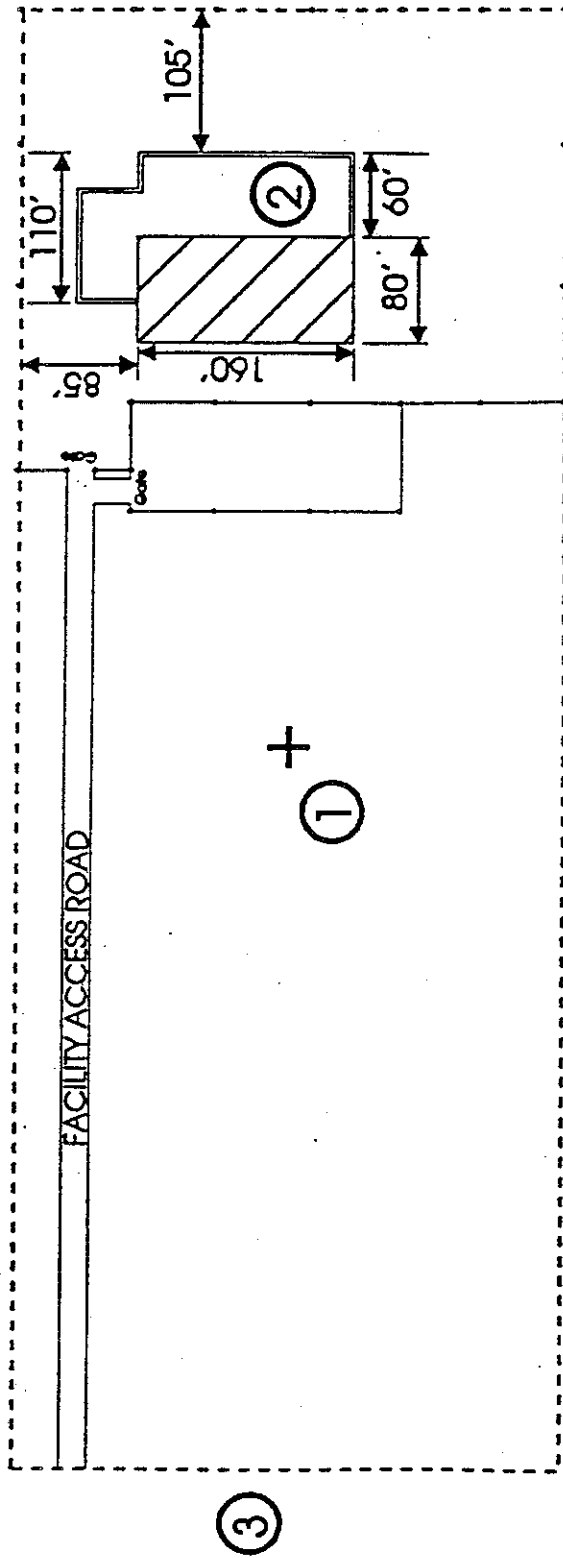

LEGEND:

① Center of Property Is Approximately N 34°-07'-50" X W 114°-16'-22"

② Uncovered Reactivation Facilities

③ Mutahar Street

----- Property Line

 Covered Storage and Maintenance Facilities


--- Fence Line

WESTATES CARBON - ARIZONA
Parker, Arizona

General Property Layout
Reactivation Facilities

Scale 1"=150'

Location:
2523 Mutahar Street
Parker, Arizona 85344

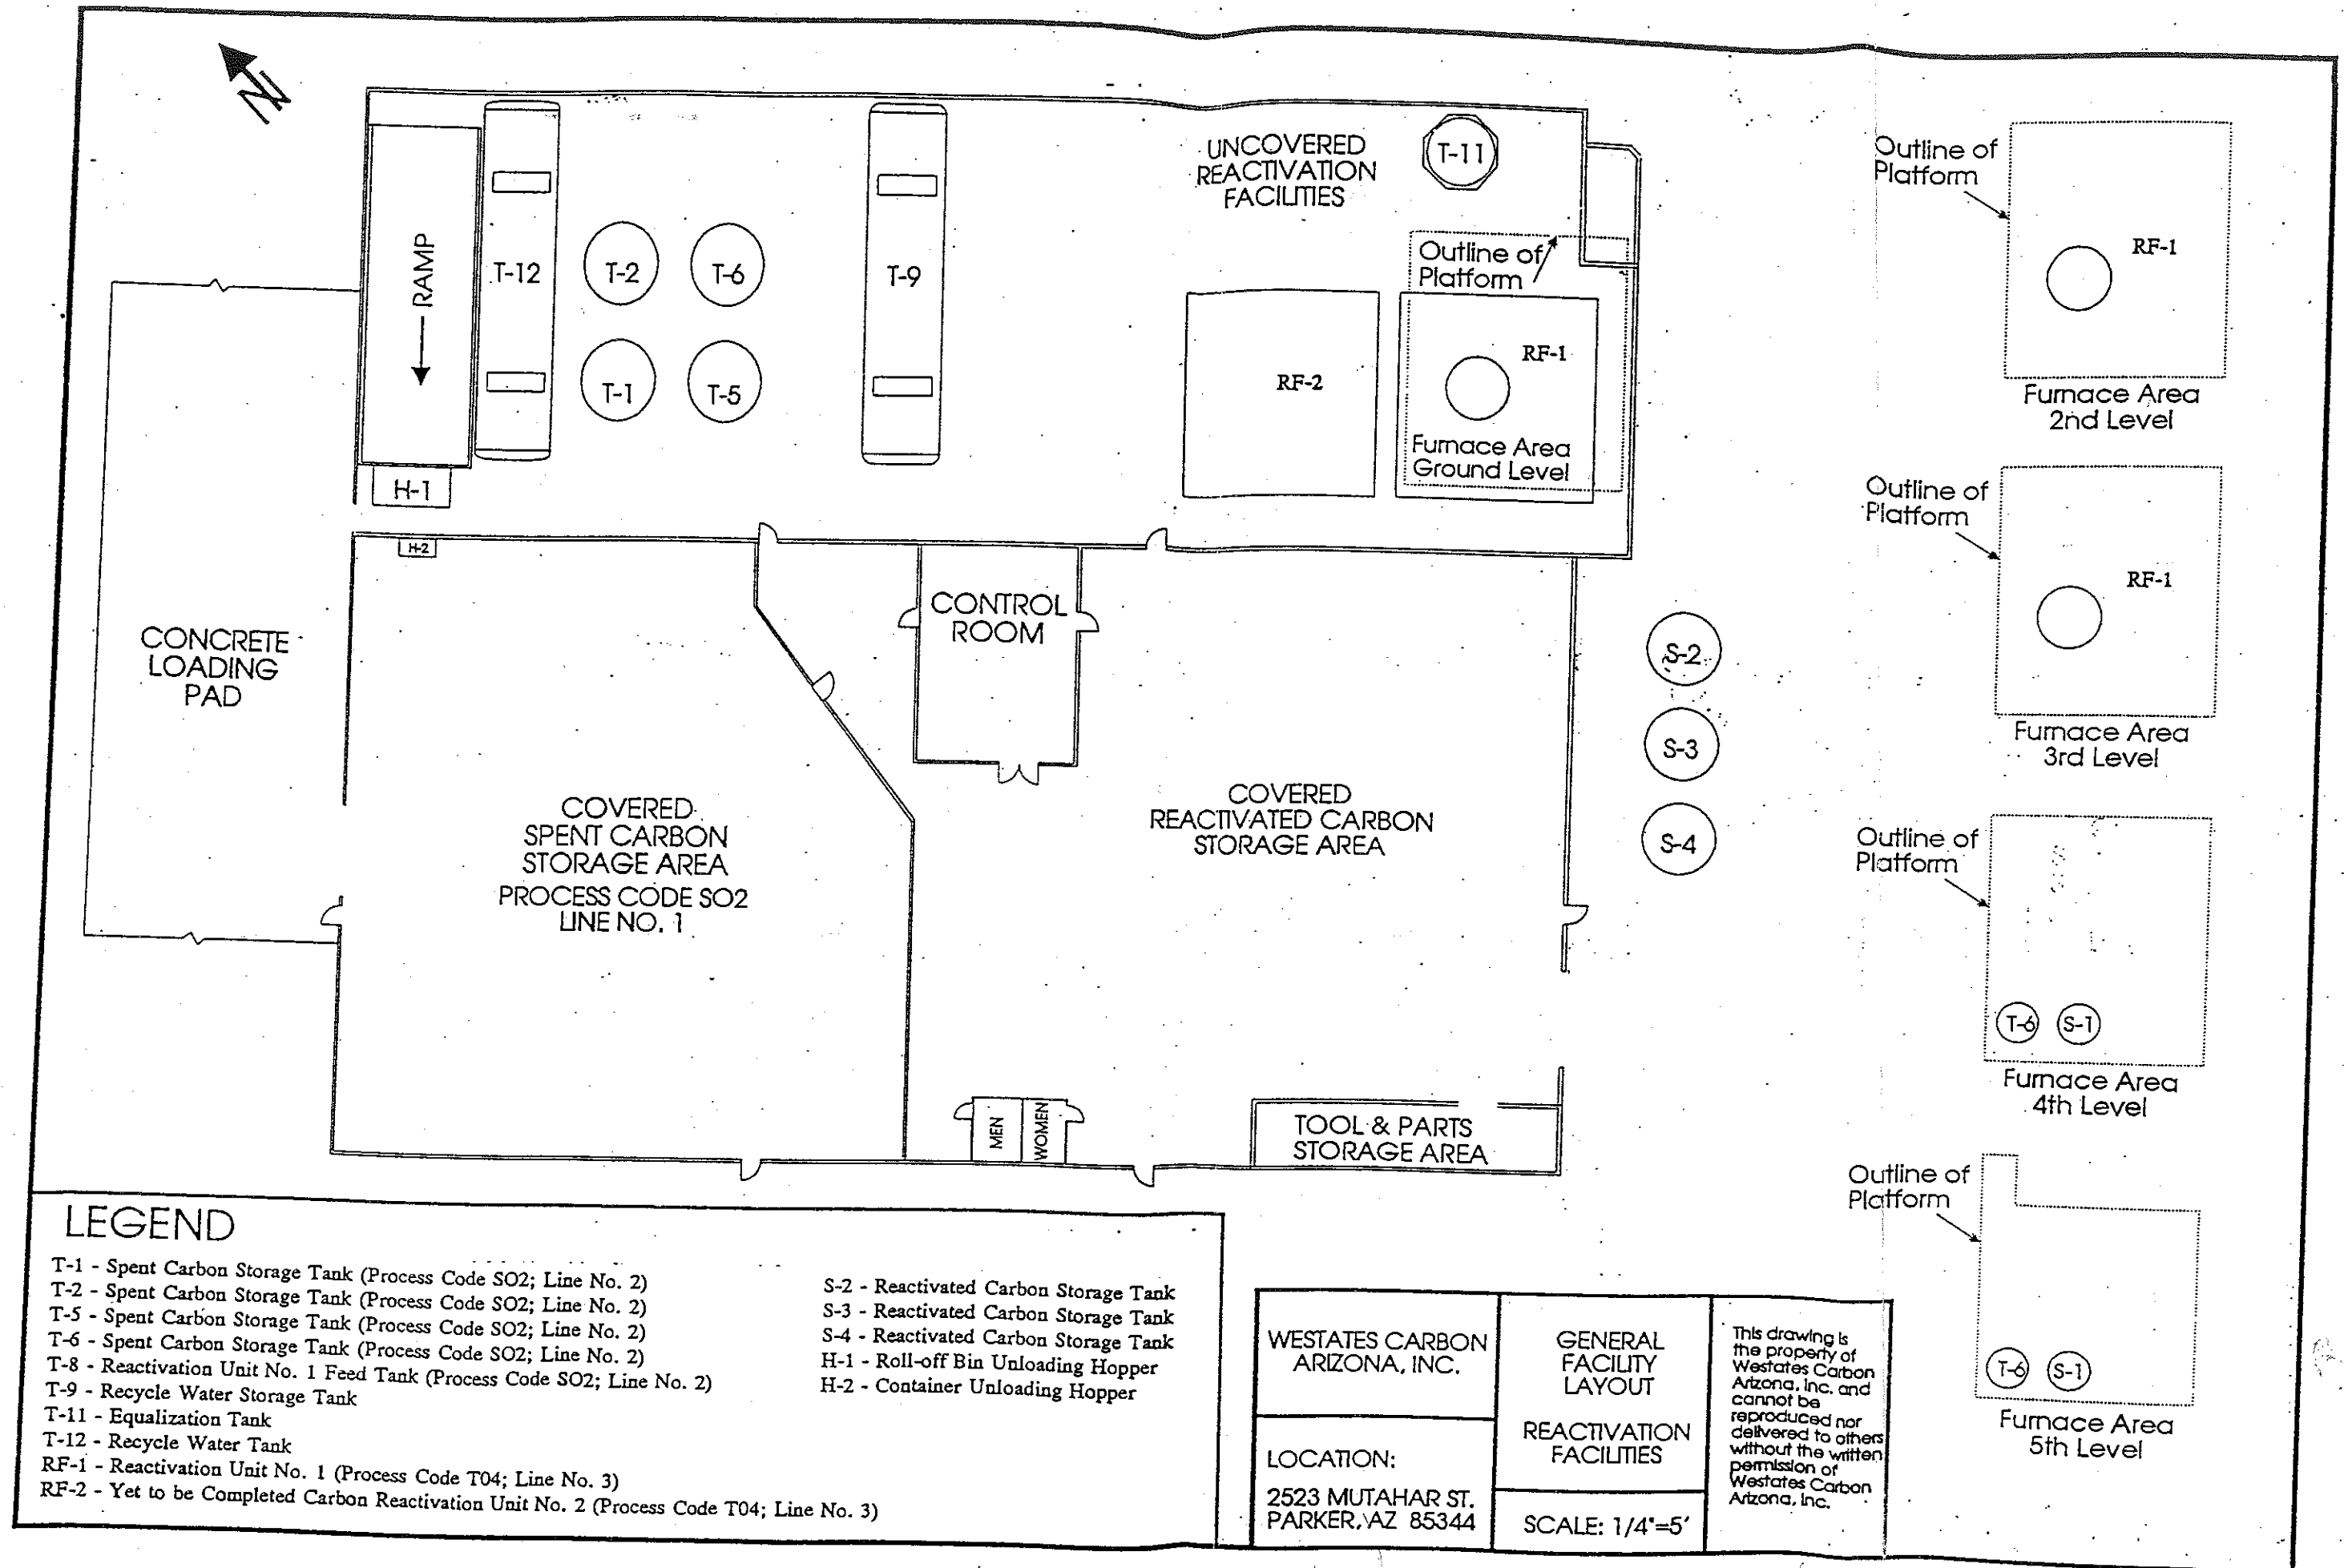

ATTACHMENT D

ITEM XVII -- PHOTOGRAPHS

1. SITE PHOTOGRAPHS
2. SITE AERIAL PHOTOGRAPHS

**Process Code S02
(Identified as Line Number 2 in Section XII)**


**Spent Carbon Storage Feed Tanks
(Tank No. T-1 and T-2)**



October 1996

**Process Code S02
(Identified as Line Number 2 in Section XII)**


**Spent Carbon Storage Feed Tanks
(Tank No. T-5 and T-6)**

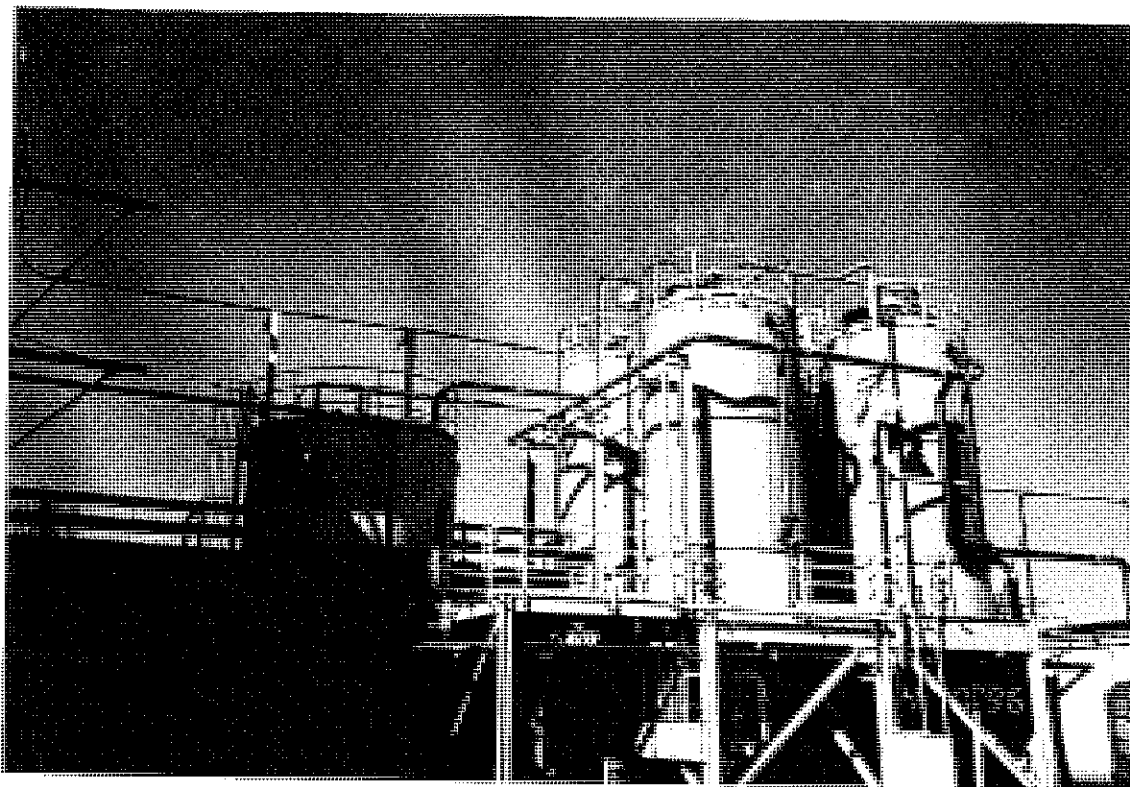

October 1996

Process Code S02
(Identified as Line Number 2 in Section XII)


Spent Carbon Storage Feed Tanks
(Tank No. T-8)

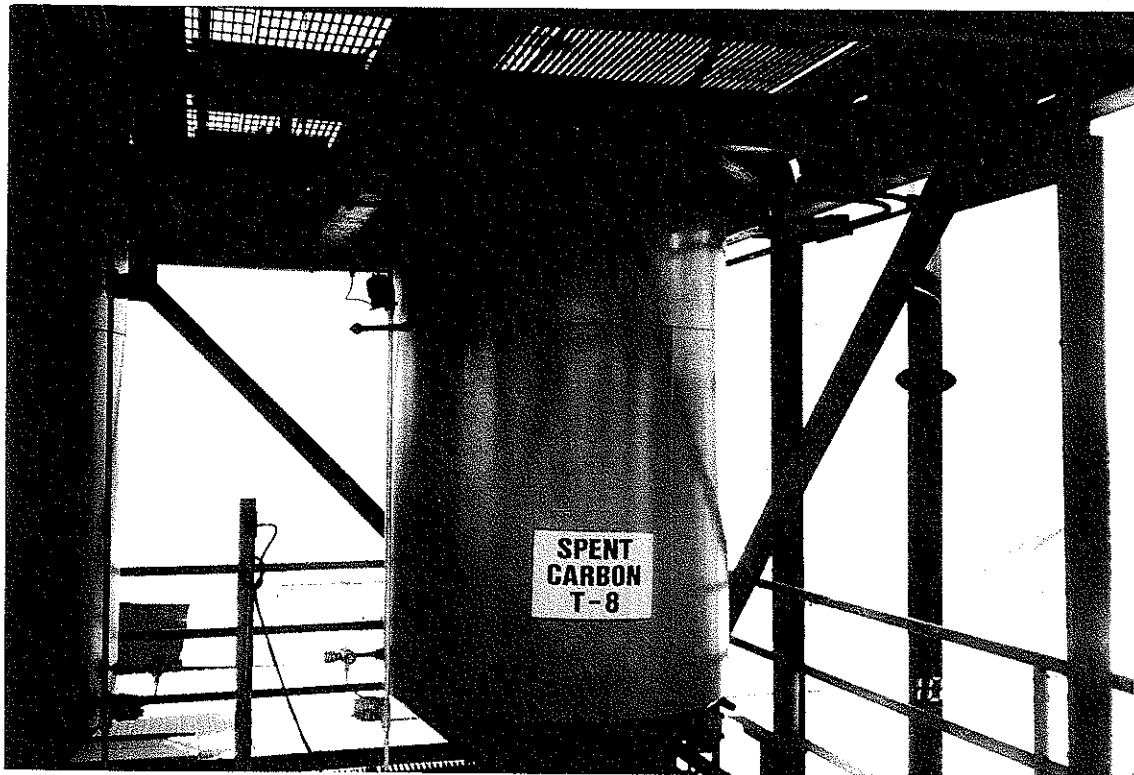

October 1996

**Process Code T04
(Identified as Line Number 3 in Section XII)**


**Carbon Reactivation Unit No.1 (RF-1)
(1 of 2)**

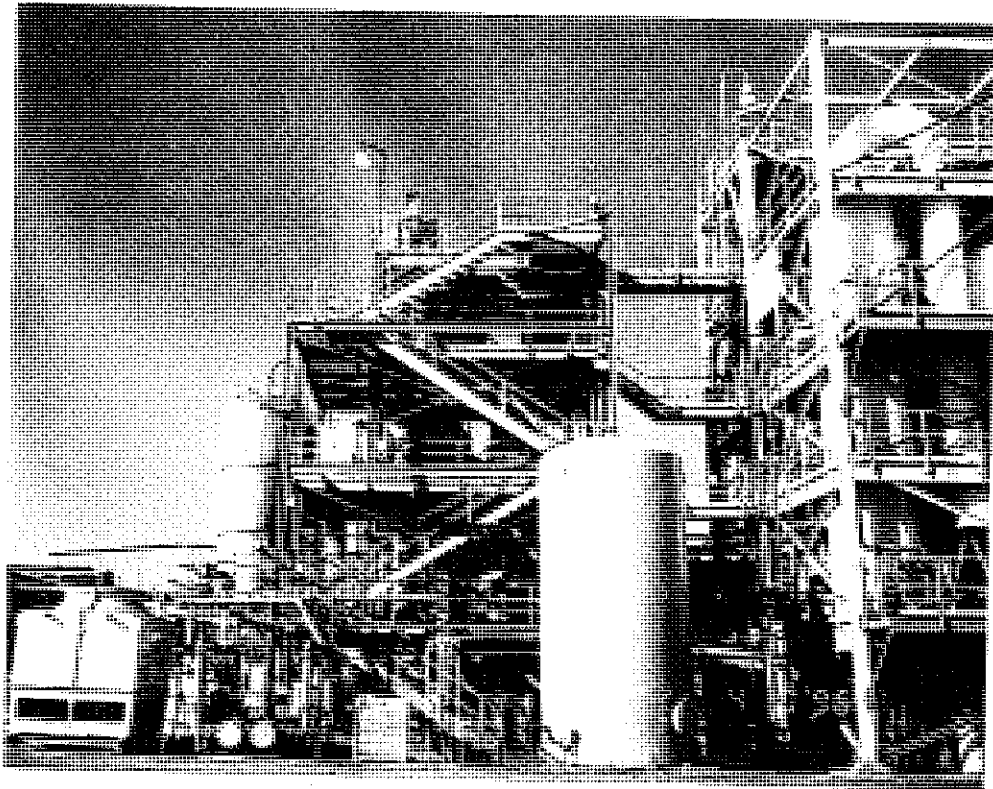

October 1996

**Process Code T04
(Identified as Line Number 3 in Section XII)**

**Carbon Reactivation Unit No.2 (RF-2)
(2 of 2)**

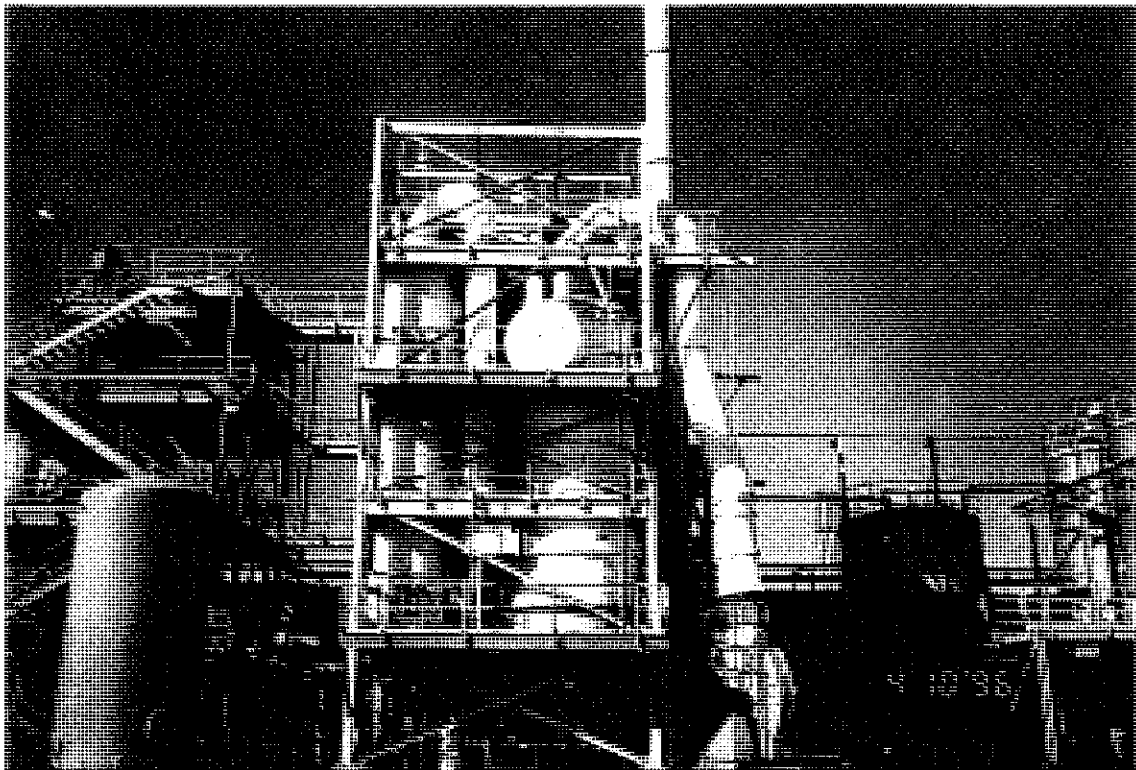

October 1996

Process Code S01
(Identified as Line Number 1 in Section XII)
Spent Carbon Storage (Warehouse)



October 1996



UNITED STATES ENVIRONMENTAL PROTECTION AGENCY

REGION IX

75 Hawthorne Street
San Francisco, Ca. 94105

MAR 25 1992

Mr. Robert Babbitt
Project Manager
Westates Carbon - Arizona, Inc.
2250 Tubeway Avenue
Los Angeles, CA 90040

Dear Mr. Babbitt:

The United States Environmental Protection Agency ("EPA") has reviewed the information you provided in a letter dated February 14, 1992, regarding the interim status eligibility of Westates Carbon-Arizona, Inc. ("Westates") (ID# AZD982441263), located on the Colorado River Indian Reservation near Parker, Arizona.

The documentation you provided verifies that construction of the Westates facility had commenced before the effective date (August 21, 1991) of the boiler and industrial furnace (BIF) rule, thereby confirming Westates' status as an existing facility, pursuant to 40 CFR 260.10 and Section 3005(e)(1)(A)(ii) of RCRA. EPA hereby confirms that you have met the requirements as an interim status facility.

EPA will "call-in" your Part B permit application at a later date considering the relative hazard to human health and environment that Westates poses compared to other storage, treatment, and disposal facilities within the Director's purview. If you have any questions regarding this matter, please contact Chris Heppe at (415) 744-2027.

Sincerely,

Paula Bisson

Paula Bisson, Chief
Arizona, Nevada, Pacific Island Section

cc: Daniel Eddy, Jr., Chairman
Colorado Indian Tribe

Revised Part A Forms

Provided for Information Purposes Only

SEND COMPLETED FORM TO: The Appropriate State or EPA Regional Office.	United States Environmental Protection Agency RCRA SUBTITLE C SITE IDENTIFICATION FORM		
1. Reason for Submittal (See instructions on page 14.) MARK ALL BOX(ES) THAT APPLY	Reason for Submittal: <input type="checkbox"/> To provide Initial Notification of Regulated Waste Activity (to obtain an EPA ID Number for hazardous waste, universal waste, or used oil activities) <input type="checkbox"/> To provide Subsequent Notification of Regulated Waste Activity (to update site identification information) <input type="checkbox"/> As a component of a First RCRA Hazardous Waste Part A Permit Application <input type="checkbox"/> As a component of a Revised RCRA Hazardous Waste Part A Permit Application (Amendment #_____) <input type="checkbox"/> As a component of the Hazardous Waste Report		
2. Site EPA ID Number (page 15)	EPA ID Number <div style="border-bottom: 1px solid black; width: 100%; text-align: center;"> </div>		
3. Site Name (page 15)	Name: <div style="border-bottom: 1px solid black; width: 100%;"></div>		
4. Site Location Information (page 15)	Street Address: <div style="border-bottom: 1px solid black; width: 100%;"></div>		
	City, Town, or Village: <div style="border-bottom: 1px solid black; width: 100%;"></div>		State: <div style="border-bottom: 1px solid black; width: 100%;"></div>
	County Name: <div style="border-bottom: 1px solid black; width: 100%;"></div>		Zip Code: <div style="border-bottom: 1px solid black; width: 100%;"></div>
5. Site Land Type (page 15)	Site Land Type: <input type="checkbox"/> Private <input type="checkbox"/> County <input type="checkbox"/> District <input type="checkbox"/> Federal <input type="checkbox"/> Indian <input type="checkbox"/> Municipal <input type="checkbox"/> State <input type="checkbox"/> Other		
6. North American Industry Classification System (NAICS) Code(s) for the Site (page 15)	A. <div style="border-bottom: 1px solid black; width: 100%; text-align: center;"> </div>		B. <div style="border-bottom: 1px solid black; width: 100%; text-align: center;"> </div>
	C. <div style="border-bottom: 1px solid black; width: 100%; text-align: center;"> </div>		D. <div style="border-bottom: 1px solid black; width: 100%; text-align: center;"> </div>
7. Site Mailing Address (page 16)	Street or P. O. Box: <div style="border-bottom: 1px solid black; width: 100%;"></div>		
	City, Town, or Village: <div style="border-bottom: 1px solid black; width: 100%;"></div>		
	State: <div style="border-bottom: 1px solid black; width: 100%;"></div>		
	Country: <div style="border-bottom: 1px solid black; width: 100%;"></div>		Zip Code: <div style="border-bottom: 1px solid black; width: 100%;"></div>
8. Site Contact Person (page 16)	First Name: <div style="border-bottom: 1px solid black; width: 100%;"></div>		MI: <div style="border-bottom: 1px solid black; width: 100%;"></div>
	Phone Number: <div style="border-bottom: 1px solid black; width: 100%;"></div>		Last Name: <div style="border-bottom: 1px solid black; width: 100%;"></div>
9. Operator and Legal Owner of the Site (pages 16 and 17)	A. Name of Site's Operator: <div style="border-bottom: 1px solid black; width: 100%;"></div>		Date Became Operator (mm/dd/yyyy): <div style="border-bottom: 1px solid black; width: 100%;"></div>
	Operator Type: <input type="checkbox"/> Private <input type="checkbox"/> County <input type="checkbox"/> District <input type="checkbox"/> Federal <input type="checkbox"/> Indian <input type="checkbox"/> Municipal <input type="checkbox"/> State <input type="checkbox"/> Other		
	B. Name of Site's Legal Owner: <div style="border-bottom: 1px solid black; width: 100%;"></div>		Date Became Owner (mm/dd/yyyy): <div style="border-bottom: 1px solid black; width: 100%;"></div>
	Owner Type: <input type="checkbox"/> Private <input type="checkbox"/> County <input type="checkbox"/> District <input type="checkbox"/> Federal <input type="checkbox"/> Indian <input type="checkbox"/> Municipal <input type="checkbox"/> State <input type="checkbox"/> Other		

9. Legal Owner (Continued) Address	Street or P. O. Box:	
	City, Town, or Village:	
	State:	
	Country:	Zip Code:

10. Type of Regulated Waste Activity

Mark "Yes" or "No" for all activities; complete any additional boxes as instructed. (See instructions on pages 18 to 21.)

A. Hazardous Waste Activities

Complete all parts for 1 through 6.

Y ☐ N ☐ 1. Generator of Hazardous Waste

If "Yes", choose only one of the following - a, b, or c.

- ☐ a. LQG: Greater than 1,000 kg/mo (2,200 lbs./mo.) of non-acute hazardous waste; or
- ☐ b. SQG: 100 to 1,000 kg/mo (220 - 2,200 lbs./mo.) of non-acute hazardous waste; or
- ☐ c. CESQG: Less than 100 kg/mo (220 lbs./mo.) of non-acute hazardous waste

In addition, indicate other generator activities.

Y ☐ N ☐ d. United States Importer of Hazardous WasteY ☐ N ☐ e. Mixed Waste (hazardous and radioactive) Generator**Y ☐ N ☐ 2. Transporter of Hazardous Waste**

Y ☐ N ☐ 3. Treater, Storer, or Disposer of Hazardous Waste (at your site) Note: A hazardous waste permit is required for this activity.

Y ☐ N ☐ 4. Recycler of Hazardous Waste (at your site)**Y ☐ N ☐ 5. Exempt Boiler and/or Industrial Furnace**

If "Yes", mark each that applies.

- ☐ a. Small Quantity On-site Burner Exemption
- ☐ b. Smelting, Melting, and Refining Furnace Exemption

Y ☐ N ☐ 6. Underground Injection Control**B. Universal Waste Activities**

Y ☐ N ☐ 1. Large Quantity Handler of Universal Waste (accumulate 5,000 kg or more) [refer to your State regulations to determine what is regulated]. Indicate types of universal waste generated and/or accumulated at your site. If "Yes", mark all boxes that apply:

	<u>Generate</u>	<u>Accumulate</u>
a. Batteries	<input type="checkbox"/>	<input type="checkbox"/>
b. Pesticides	<input type="checkbox"/>	<input type="checkbox"/>
c. Thermostats	<input type="checkbox"/>	<input type="checkbox"/>
d. Lamps	<input type="checkbox"/>	<input type="checkbox"/>
e. Other (specify) _____	<input type="checkbox"/>	<input type="checkbox"/>
f. Other (specify) _____	<input type="checkbox"/>	<input type="checkbox"/>
g. Other (specify) _____	<input type="checkbox"/>	<input type="checkbox"/>

Y ☐ N ☐ 2. Destination Facility for Universal Waste

Note: A hazardous waste permit may be required for this activity.

C. Used Oil Activities

Mark all boxes that apply.

Y ☐ N ☐ 1. Used Oil Transporter

If "Yes", mark each that applies.

- ☐ a. Transporter
- ☐ b. Transfer Facility

Y ☐ N ☐ 2. Used Oil Processor and/or Re-refiner

If "Yes", mark each that applies.

- ☐ a. Processor
- ☐ b. Re-refiner

Y ☐ N ☐ 3. Off-Specification Used Oil Burner**Y ☐ N ☐ 4. Used Oil Fuel Marketer**

If "Yes", mark each that applies.

- ☐ a. Marketer Who Directs Shipment of Off-Specification Used Oil to Off-Specification Used Oil Burner
- ☐ b. Marketer Who First Claims the Used Oil Meets the Specifications

11. Description of Hazardous Wastes (See instructions on page 22.)

A. Waste Codes for Federally Regulated Hazardous Wastes. Please list the waste codes of the Federal hazardous wastes handled at your site. List them in the order they are presented in the regulations (e.g., D001, D003, F007, U112). Use an additional page if more spaces are needed.

B. Waste Codes for State-Regulated (i.e., non-Federal) Hazardous Wastes. Please list the waste codes of the State-regulated hazardous wastes handled at your site. List them in the order they are presented in the regulations. Use an additional page if more spaces are needed for waste codes.

12. Comments (See instructions on page 22.)

13. Certification. I certify under penalty of law that this document and all attachments were prepared under my direction or supervision in accordance with a system designed to assure that qualified personnel properly gather and evaluate the information submitted. Based on my inquiry of the person or persons who manage the system, or those persons directly responsible for gathering the information, the information submitted is, to the best of my knowledge and belief, true, accurate, and complete. I am aware that there are significant penalties for submitting false information, including the possibility of fine and imprisonment for knowing violations.

For the RCRA Hazardous Waste Part A Permit Application, all operator(s) and owner(s) must sign (see 40 CFR 270.10 (b) and 270.11).

(See instructions on page 22.)

Signature of operator, owner, or an authorized representative	Name and Official Title (type or print)	Date Signed (mm/dd/yyyy)

United States Environmental Protection Agency

1. Facility Permit Contact (See instructions on page 23)	First Name:	MI:	Last Name:												
	Phone Number:		Phone Number Extension:												
2. Facility Permit Contact Mailing Address (See instructions on page 23)	Street or P.O. Box:														
	City, Town, or Village:														
	State:														
	Country:		Zip Code:												
3. Operator Mailing Address and Telephone Number (See instructions on page 23)	Street or P.O. Box:														
	City, Town, or Village:														
	State:														
	Country:	Zip Code:	Phone Number												
4. Legal Owner Mailing Address and Telephone Number (See instructions on page 23)	Street or P.O. Box:														
	City, Town, or Village:														
	State:														
	Country:	Zip Code:	Phone Number												
5. Facility Existence Date (See instructions on page 24)	Facility Existence Date (mm/dd/yyyy):														
6. Other Environmental Permits (See instructions on page 24)															
A. Permit Type (Enter code)	B. Permit Number								C. Description						
7. Nature of Business (Provide a brief description; see instructions on page 24)															

8. Process Codes and Design Capacities (See instructions on page 24) - Enter information in the Sections on Form Page 3.

A. PROCESS CODE - Enter the code from the list of process codes in the table below that best describes each process to be used at the facility. Fifteen lines are provided for entering codes. If more lines are needed, attach a separate sheet of paper with the additional information. For "other" processes (i.e., D99, S99, T04 and X99), enter the process information in Item 9 (including a description).

B. PROCESS DESIGN CAPACITY - For each code entered in Section A, enter the capacity of the process.

1. AMOUNT - Enter the amount. In a case where design capacity is not applicable (such as in a closure/post-closure or enforcement action) enter the total amount of waste for that process.

2. UNIT OF MEASURE - For each amount entered in Section B(1), enter the code in Section B(2) from the list of unit of measure codes below that describes the unit of measure used. Select only from the units of measure in this list.

C. PROCESS TOTAL NUMBER OF UNITS - Enter the total number of units for each corresponding process code.

PROCESS CODE	PROCESS	APPROPRIATE UNITS OF MEASURE FOR PROCESS DESIGN CAPACITY	PROCESS CODE	PROCESS	APPROPRIATE UNITS OF MEASURE FOR PROCESS DESIGN CAPACITY
	<u>Disposal:</u>			<u>Treatment (continued):</u>	
D79	Underground Injection Well Disposal	Gallons; Liters; Gallons Per Day; or Liters Per Day	T81	Cement Kiln	For T81-T93:
D80	Landfill	Acre-feet; Hectare-meter; Acres; Cubic Meters; Hectares; Cubic Yards	T82	Lime Kiln	
D81	Land Treatment	Acres or Hectares	T83	Aggregate Kiln	Gallons Per Day; Liters Per Day; Pounds
D82	Ocean Disposal	Gallons Per Day or Liters Per Day	T84	Phosphate Kiln	Per Hour; Short Tons Per Hour; Kilograms
D83	Surface Impoundment Disposal	Gallons; Liters; Cubic Meters; or Cubic Yards	T85	Coke Oven	Per Hour; Metric Tons Per Day; Metric
D99	Other Disposal	Any Unit of Measure in Code Table Below	T86	Blast Furnace	Tons Per Hour; Short Tons Per Day; Btu Per
	<u>Storage:</u>				
S01	Container	Gallons; Liters; Cubic Meters; or Cubic Yards	T87	Smelting, Melting, or Refining Furnace	Hour; Liters Per Hour; Kilograms Per
S02	Tank Storage	Gallons; Liters; Cubic Meters; or Cubic Yards	T88	Titanium Dioxide Chloride Oxidation Reactor	Hour; or Million Btu Per Hour
S03	Waste Pile	Cubic Yards or Cubic Meters	T89	Methane Reforming Furnace	
S04	Surface Impoundment Storage	Gallons; Liters; Cubic Meters; or Cubic Yards	T90	Pulping Liquor Recovery Furnace	
S05	Drip Pad	Gallons; Liters; Acres; Cubic Meters; Hectares; or Cubic Yards	T91	Combustion Device Used In The Recovery Of Sulfur Values From Spent Sulfuric Acid	
S06	Containment Building Storage	Cubic Yards or Cubic Meters	T92	Halogen Acid Furnaces	
S99	Other Storage	Any Unit of Measure in Code Table Below	T93	Other Industrial Furnaces Listed In 40 CFR §260.10	
	<u>Treatment:</u>				
T01	Tank Treatment	Gallons Per Day; Liters Per Day	T94	Containment Building - Treatment	Cubic Yards; Cubic Meters; Short Tons Per
T02	Surface Impoundment Treatment	Gallons Per Day; Liters Per Day			Hour; Gallons Per Hour; Liters Per Hour; Btu Per Hour; Pounds Per Hour; Short Tons
T03	Incinerator	Short Tons Per Hour; Metric Tons Per Hour; Gallons Per Hour; Liters Per Hour; Btu Per Hour; Pounds Per Hour; Short Tons Per Day; Kilograms Per Hour; Gallons Per Day; Liters Per Day; Metric Tons Per Hour; or Million Btu Per Hour			Per Day; Gallons Per Day; Liters Per Day; Metric Tons Per Hour; or Million Btu Per Hour
T04	Other Treatment	Gallons Per Day; Liters Per Day; Pounds Per Hour; Short Tons Per Hour; Kilograms Per Hour; Metric Tons Per Day; Metric Tons Per Hour; Short Tons Per Day; Btu Per Hour; Gallons Per Day; Liters Per Hour; or Million Btu Per Hour		<u>Miscellaneous (Subpart X):</u>	
T80	Boiler	Gallons; Liters; Gallons Per Hour; Liters Per Hour; Btu Per Hour; or Million Btu Per Hour	X01	Open Burning/Open Detonation	Any Unit of Measure in Code Table Below
			X02	Mechanical Processing	Short Tons Per Hour; Metric Tons Per
					Hour; Short Tons Per Day; Metric Tons Per
			X03	Thermal Unit	Day; Pounds Per Hour; Kilograms Per
					Hour; Gallons Per Hour; Liters Per Hour; or Gallons Per Day
			X04	Geologic Repository	Gallons Per Day; Liters Per Day; Pounds
					Per Hour; Short Tons Per Hour; Kilograms
					Per Hour; Metric Tons Per Day; Metric
			X99	Other Subpart X	Tons Per Hour; Short Tons Per Day; Btu Per Hour; or Million Btu Per Hour
					Cubic Yards; Cubic Meters; Acre-feet; Hectare-meter; Gallons; or Liters
					Any Unit of Measure Listed Below

UNIT OF MEASURE	UNIT OF MEASURE CODE	UNIT OF MEASURE	UNIT OF MEASURE CODE	UNIT OF MEASURE	UNIT OF MEASURE CODE
Gallons.....	G	Short Tons Per Hour.....	D	Cubic Yards.....	Y
Gallons Per Hour.....	E	Metric Tons Per Hour.....	W	Cubic Meters.....	C
Gallons Per Day.....	U	Short Tons Per Day.....	N	Acres.....	B
Liters.....	L	Metric Tons Per Day.....	S	Acre-feet.....	A
Liters Per Hour.....	H	Pounds Per Hour.....	J	Hectares.....	Q
Liters Per Day.....	V	Kilograms Per Hour.....	R	Hectare-meter.....	F
		Million Btu Per Hour.....	X	Btu Per Hour.....	I

EXAMPLE FOR COMPLETING Item 8 (shown in line number X-1 below): A facility has a storage tank, which can hold 533.788 gallons.

NOTE: If you need to list more than 15 process codes, attach an additional sheet(s) with the information in the same format as above. Number the lines sequentially, taking into account any lines that will be used for "other" processes (i.e., D99, S99, T04 and X99) in Item 9.

<i>Line Number</i> <i>(Enter #s in sequence with Item 8)</i>	<i>A.</i> <i>Process Code</i> <i>(From list above)</i>				<i>B. PROCESS DESIGN CAPACITY</i>		<i>C.</i> <i>Process Total</i> <i>Number of Units</i>	<i>D. Description of Process</i>
				<i>(1) Amount (Specify)</i>	<i>(2) Unit of Measure</i> <i>(Enter code)</i>			
X	2	T	0	4	1 0 0 . 0 0 0	U	0 0 1	In-situ Vitrification
					.			
					.			
					.			
					.			
					.			
					.			

10. Description of Hazardous Wastes (See instructions on page 25) - Enter information in the Sections on Form Page 5.

- A. EPA HAZARDOUS WASTE NUMBER** - Enter the four-digit number from 40 CFR, Part 261 Subpart D of each listed hazardous waste you will handle. For hazardous wastes which are not listed in 40 CFR, Part 261 Subpart D, enter the four-digit number(s) from 40 CFR Part 261, Subpart C that describes the characteristics and/or the toxic contaminants of those hazardous wastes.
- B. ESTIMATED ANNUAL QUANTITY** - For each listed waste entered in Section A, estimate the quantity of that waste that will be handled on an annual basis. For each characteristic or toxic contaminant entered in Section A, estimate the total annual quantity of all the non-listed waste(s) that will be handled which possess that characteristic or contaminant.
- C. UNIT OF MEASURE** - For each quantity entered in Section B, enter the unit of measure code. Units of measure which must be used and the appropriate codes are:

ENGLISH UNIT OF MEASURE	CODE	METRIC UNIT OF MEASURE	CODE
POUNDS	P	KILOGRAMS	K
TONS	T	METRIC TONS	M

If facility records use any other unit of measure for quantity, the units of measure must be converted into one of the required units of measure, taking into account the appropriate density or specific gravity of the waste.

D. PROCESSES**1. PROCESS CODES:**

For listed hazardous waste: For each listed hazardous waste entered in Section A, select the code(s) from the list of process codes contained in Items 8A and 9A on page 3 to indicate all the processes that will be used to store, treat, and/or dispose of all the listed hazardous wastes.

For non-listed hazardous waste: For each characteristic or toxic contaminant entered in Section A, select the code(s) from the list of process codes contained in Items 8A and 9A on page 3 to indicate all the processes that will be used to store, treat, and/or dispose of all the non-listed hazardous wastes that possess that characteristic or toxic contaminant.

NOTE: THREE SPACES ARE PROVIDED FOR ENTERING PROCESS CODES. IF MORE ARE NEEDED:

1. Enter the first two as described above.
2. Enter "000" in the extreme right box of Item 10.D(1).
3. Use additional sheet, enter line number from previous sheet, and enter additional code(s) in Item 10.E.

2. PROCESS DESCRIPTION: If a code is not listed for a process that will be used, describe the process in Item 10.D(2) or in Item 10.E(2).

NOTE: HAZARDOUS WASTES DESCRIBED BY MORE THAN ONE EPA HAZARDOUS WASTE NUMBER - Hazardous wastes that can be described by more than one EPA Hazardous Waste Number shall be described on the form as follows:

1. Select one of the EPA Hazardous Waste Numbers and enter it in Section A. On the same line complete Sections B, C and D by estimating the total annual quantity of the waste and describing all the processes to be used to treat, store, and/or dispose of the waste.
2. In Section A of the next line enter the other EPA Hazardous Waste Number that can be used to describe the waste. In Section D(2) on that line enter "included with above" and make no other entries on that line.
3. Repeat step 2 for each EPA Hazardous Waste Number that can be used to describe the hazardous waste.

EXAMPLE FOR COMPLETING Item 10 (shown in line numbers X-1, X-2, X-3, and X-4 below) - A facility will treat and dispose of an estimated 900 pounds per year of chrome shavings from leather tanning and finishing operations. In addition, the facility will treat and dispose of three non-listed wastes. Two wastes are corrosive only and there will be an estimated 200 pounds per year of each waste. The other waste is corrosive and ignitable and there will be an estimated 100 pounds per year of that waste. Treatment will be in an incinerator and disposal will be in a landfill.

Line Number	A. EPA Hazardous Waste No. (Enter code)				B. Estimated Annual Quantity of Waste	C. Unit of Measure (Enter code)	D. PROCESSES									
							(1) PROCESS CODES (Enter code)									
X	1	K	0	5	4	900	P	T	0	3	D	8	0			
X	2	D	0	0	2	400	P	T	0	3	D	8	0			
X	3	D	0	0	1	100	P	T	0	3	D	8	0			
X	4	D	0	0	2											Included With Above

10. Description of Hazardous Wastes (Continued. Use the Additional Sheet(s) as necessary; number pages as 5 a, etc.)

Line Number	A. EPA Hazardous Waste No. (Enter code)	B. Estimated Annual Quantity of Waste	C. Unit of Measure (Enter code)	D. PROCESSES												(2) PROCESS DESCRIPTION (If a code is not entered in D(1))
				(1) PROCESS CODES (Enter code)												
1																
2																
3																
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10. Description of Hazardous Wastes (Continued. Use this Additional Sheet (s) as necessary; number as 5a, etc.)

Line Number	A. EPA Hazardous Waste No. (Enter code)					B. Estimated Annual Quantity of Waste	C. Unit of Measure (Enter code)	E. PROCESSES									
	(1) PROCESS CODES (Enter code)										(2) PROCESS DESCRIPTION (If a code is not entered in E(1))						
7	9	K	0	3	1	5,000	P	S	0	1	S	0	2	X	0	3	
8	0	K	0	3	2	5,000	P	S	0	1	S	0	2	X	0	3	
8	1	K	0	3	3	5,000	P	S	0	1	S	0	2	X	0	3	
8	2	K	0	3	4	5,000	P	S	0	1	S	0	2	X	0	3	
8	3	K	0	3	5	5,000	P	S	0	1	S	0	2	X	0	3	
8	4	K	0	3	6	5,000	P	S	0	1	S	0	2	X	0	3	
8	5	K	0	3	7	5,000	P	S	0	1	S	0	2	X	0	3	
8	6	K	0	3	8	5,000	P	S	0	1	S	0	2	X	0	3	
8	7	K	0	3	9	5,000	P	S	0	1	S	0	2	X	0	3	
8	8	K	0	4	0	5,000	P	S	0	1	S	0	2	X	0	3	
8	9	K	0	4	1	5,000	P	S	0	1	S	0	2	X	0	3	
9	0	K	0	4	1	5,000	P	S	0	1	S	0	2	X	0	3	
9	1	K	0	4	6	5,000	P	S	0	1	S	0	2	X	0	3	
9	2	K	0	4	8	5,000	P	S	0	1	S	0	2	X	0	3	
9	3	K	0	4	9	5,000	P	S	0	1	S	0	2	X	0	3	
9	4	K	0	5	0	5,000	P	S	0	1	S	0	2	X	0	3	
9	5	K	0	5	1	5,000	P	S	0	1	S	0	2	X	0	3	
9	6	K	0	5	2	5,000	P	S	0	1	S	0	2	X	0	3	
9	7	K	0	6	1	5,000	P	S	0	1	S	0	2	X	0	3	
9	8	K	0	6	4	5,000	P	S	0	1	S	0	2	X	0	3	
9	9	K	0	6	5	5,000	P	S	0	1	S	0	2	X	0	3	
10	0	K	0	6	6	5,000	P	S	0	1	S	0	2	X	0	3	
10	1	K	0	7	1	5,000	P	S	0	1	S	0	2	X	0	3	
10	2	K	0	7	3	5,000	P	S	0	1	S	0	2	X	0	3	
10	3	K	0	8	3	5,000	P	S	0	1	S	0	2	X	0	3	
10	4	K	0	8	4	5,000	P	S	0	1	S	0	2	X	0	3	
10	5	K	0	8	5	5,000	P	S	0	1	S	0	2	X	0	3	
10	6	K	0	8	6	5,000	P	S	0	1	S	0	2	X	0	3	
10	7	K	0	8	7	5,000	P	S	0	1	S	0	2	X	0	3	
10	8	K	0	8	8	5,000	P	S	0	1	S	0	2	X	0	3	
10	9	K	0	9	0	5,000	P	S	0	1	S	0	2	X	0	3	
11	0	K	0	9	1	5,000	P	S	0	1	S	0	2	X	0	3	
11	1	K	0	9	3	5,000	P	S	0	1	S	0	2	X	0	3	
11	2	K	0	9	4	5,000	P	S	0	1	S	0	2	X	0	3	
11	3	K	0	9	5	5,000	P	S	0	1	S	0	2	X	0	3	
11	4	K	0	9	6	5,000	P	S	0	1	S	0	2	X	0	3	
11	5	K	0	9	7	5,000	P	S	0	1	S	0	2	X	0	3	
11	6	K	0	9	8	5,000	P	S	0	1	S	0	2	X	0	3	
11	7	K	1	0	0	5,000	P	S	0	1	S	0	2	X	0	3	

10. Description of Hazardous Wastes (Continued. Use this Additional Sheet (s) as necessary; number as 5a, etc.)

Line Number	A.					B. Estimated Annual Quantity of Waste	C. Unit of Measure (Enter code)	E. PROCESSES										(2) PROCESS DESCRIPTION (If a code is not entered in E(1))
	EPA Hazardous Waste No. (Enter code)							(1) PROCESS CODES (Enter code)										
11	8	K	1	0	1	5,000	P	S	0	1	S	0	2	X	0	3		
11	9	K	1	0	2	5,000	P	S	0	1	S	0	2	X	0	3		
12	0	K	1	0	3	5,000	P	S	0	1	S	0	2	X	0	3		
12	1	K	1	0	4	5,000	P	S	0	1	S	0	2	X	0	3		
12	2	K	1	0	5	5,000	P	S	0	1	S	0	2	X	0	3		
12	3	K	1	0	6	5,000	P	S	0	1	S	0	2	X	0	3		
12	4	K	1	1	2	5,000	P	S	0	1	S	0	2	X	0	3		
12	5	K	1	1	3	5,000	P	S	0	1	S	0	2	X	0	3		
12	6	K	1	1	4	5,000	P	S	0	1	S	0	2	X	0	3		
12	7	K	1	1	5	5,000	P	S	0	1	S	0	2	X	0	3		
12	8	K	1	1	6	5,000	P	S	0	1	S	0	2	X	0	3		
12	9	K	1	1	7	5,000	P	S	0	1	S	0	2	X	0	3		
13	0	K	1	1	8	5,000	P	S	0	1	S	0	2	X	0	3		
13	1	K	1	2	5	5,000	P	S	0	1	S	0	2	X	0	3		
13	2	K	1	2	6	5,000	P	S	0	1	S	0	2	X	0	3		
13	3	P	0	0	1	5,000	P	S	0	1	S	0	2	X	0	3		
13	4	P	0	0	2	5,000	P	S	0	1	S	0	2	X	0	3		
13	5	P	0	0	3	5,000	P	S	0	1	S	0	2	X	0	3		
13	6	P	0	0	4	5,000	P	S	0	1	S	0	2	X	0	3		
13	7	P	0	0	5	5,000	P	S	0	1	S	0	2	X	0	3		
13	8	P	0	0	7	5,000	P	S	0	1	S	0	2	X	0	3		
13	9	P	0	0	8	5,000	P	S	0	1	S	0	2	X	0	3		
14	0	P	0	1	0	5,000	P	S	0	1	S	0	2	X	0	3		
14	1	P	0	1	1	5,000	P	S	0	1	S	0	2	X	0	3		
14	2	P	0	1	2	5,000	P	S	0	1	S	0	2	X	0	3		
14	3	P	0	1	3	5,000	P	S	0	1	S	0	2	X	0	3		
14	4	P	0	1	4	5,000	P	S	0	1	S	0	2	X	0	3		
14	5	P	0	1	5	5,000	P	S	0	1	S	0	2	X	0	3		
14	6	P	0	1	6	5,000	P	S	0	1	S	0	2	X	0	3		
14	7	P	0	1	7	5,000	P	S	0	1	S	0	2	X	0	3		
14	8	P	0	1	8	5,000	P	S	0	1	S	0	2	X	0	3		
14	9	P	0	2	0	5,000	P	S	0	1	S	0	2	X	0	3		
15	0	P	0	2	1	5,000	P	S	0	1	S	0	2	X	0	3		
15	1	P	0	2	2	5,000	P	S	0	1	S	0	2	X	0	3		
15	2	P	0	2	3	5,000	P	S	0	1	S	0	2	X	0	3		
15	3	P	0	2	4	5,000	P	S	0	1	S	0	2	X	0	3		
15	4	P	0	2	6	5,000	P	S	0	1	S	0	2	X	0	3		
15	5	P	0	2	7	5,000	P	S	0	1	S	0	2	X	0	3		
15	6	P	0	2	8	5,000	P	S	0	1	S	0	2	X	0	3		

10. Description of Hazardous Wastes (Continued. Use this Additional Sheet (s) as necessary; number as 5a, etc.)

Line Number	A. EPA Hazardous Waste No. (Enter code)					B. Estimated Annual Quantity of Waste	C. Unit of Measure (Enter code)	E. PROCESSES									
	(1) PROCESS CODES (Enter code)										(2) PROCESS DESCRIPTION (If a code is not entered in E(1))						
15	7	P	0	2	9	5,000	P	S	0	1	S	0	2	X	0	3	
15	8	P	0	3	0	5,000	P	S	0	1	S	0	2	X	0	3	
15	9	P	0	3	1	5,000	P	S	0	1	S	0	2	X	0	3	
16	0	P	0	3	3	5,000	P	S	0	1	S	0	2	X	0	3	
16	1	P	0	3	4	5,000	P	S	0	1	S	0	2	X	0	3	
16	2	P	0	3	6	5,000	P	S	0	1	S	0	2	X	0	3	
16	3	P	0	3	7	5,000	P	S	0	1	S	0	2	X	0	3	
16	4	P	0	3	8	5,000	P	S	0	1	S	0	2	X	0	3	
16	5	P	0	3	9	5,000	P	S	0	1	S	0	2	X	0	3	
16	6	P	0	4	0	5,000	P	S	0	1	S	0	2	X	0	3	
16	7	P	0	4	1	5,000	P	S	0	1	S	0	2	X	0	3	
16	8	P	0	4	2	5,000	P	S	0	1	S	0	2	X	0	3	
16	9	P	0	4	3	5,000	P	S	0	1	S	0	2	X	0	3	
17	0	P	0	4	4	5,000	P	S	0	1	S	0	2	X	0	3	
17	1	P	0	4	5	5,000	P	S	0	1	S	0	2	X	0	3	
17	2	P	0	4	6	5,000	P	S	0	1	S	0	2	X	0	3	
17	3	P	0	4	7	5,000	P	S	0	1	S	0	2	X	0	3	
17	4	P	0	4	8	5,000	P	S	0	1	S	0	2	X	0	3	
17	5	P	0	4	9	5,000	P	S	0	1	S	0	2	X	0	3	
17	6	P	0	5	0	5,000	P	S	0	1	S	0	2	X	0	3	
17	7	P	0	5	1	5,000	P	S	0	1	S	0	2	X	0	3	
17	8	P	0	5	4	5,000	P	S	0	1	S	0	2	X	0	3	
17	9	P	0	5	6	5,000	P	S	0	1	S	0	2	X	0	3	
18	0	P	0	5	7	5,000	P	S	0	1	S	0	2	X	0	3	
18	1	P	0	5	8	5,000	P	S	0	1	S	0	2	X	0	3	
18	2	P	0	5	9	5,000	P	S	0	1	S	0	2	X	0	3	
18	3	P	0	6	0	5,000	P	S	0	1	S	0	2	X	0	3	
18	4	P	0	6	2	5,000	P	S	0	1	S	0	2	X	0	3	
18	5	P	0	6	3	5,000	P	S	0	1	S	0	2	X	0	3	
18	6	P	0	6	4	5,000	P	S	0	1	S	0	2	X	0	3	
18	7	P	0	6	6	5,000	P	S	0	1	S	0	2	X	0	3	
18	8	P	0	6	7	5,000	P	S	0	1	S	0	2	X	0	3	
18	9	P	0	6	8	5,000	P	S	0	1	S	0	2	X	0	3	
19	0	P	0	6	9	5,000	P	S	0	1	S	0	2	X	0	3	
19	1	P	0	7	0	5,000	P	S	0	1	S	0	2	X	0	3	
19	2	P	0	7	1	5,000	P	S	0	1	S	0	2	X	0	3	
19	3	P	0	7	2	5,000	P	S	0	1	S	0	2	X	0	3	
19	4	P	0	7	3	5,000	P	S	0	1	S	0	2	X	0	3	
19	5	P	0	7	4	5,000	P	S	0	1	S	0	2	X	0	3	

10. Description of Hazardous Wastes (Continued. Use this Additional Sheet (s) as necessary; number as 5a, etc.)

Line Number	A. EPA Hazardous Waste No. (Enter code)				B. Estimated Annual Quantity of Waste	C. Unit of Measure (Enter code)	E. PROCESSES										
	(1) PROCESS CODES (Enter code)										(2) PROCESS DESCRIPTION (If a code is not entered in E(1))						
	S	0	1	S			0	2	X	0		3					
19	6	P	0	7	5	5,000	P	S	0	1	S	0	2	X	0	3	
19	7	P	0	7	7	5,000	P	S	0	1	S	0	2	X	0	3	
19	8	P	0	7	8	5,000	P	S	0	1	S	0	2	X	0	3	
19	9	P	0	8	2	5,000	P	S	0	1	S	0	2	X	0	3	
20	0	P	0	8	4	5,000	P	S	0	1	S	0	2	X	0	3	
20	1	P	0	8	5	5,000	P	S	0	1	S	0	2	X	0	3	
20	2	P	0	8	7	5,000	P	S	0	1	S	0	2	X	0	3	
20	3	P	0	8	8	5,000	P	S	0	1	S	0	2	X	0	3	
20	4	P	0	8	9	5,000	P	S	0	1	S	0	2	X	0	3	
20	5	P	0	9	2	5,000	P	S	0	1	S	0	2	X	0	3	
20	6	P	0	9	3	5,000	P	S	0	1	S	0	2	X	0	3	
20	7	P	0	9	4	5,000	P	S	0	1	S	0	2	X	0	3	
20	8	P	0	9	5	5,000	P	S	0	1	S	0	2	X	0	3	
20	9	P	0	9	6	5,000	P	S	0	1	S	0	2	X	0	3	
21	0	P	0	9	7	5,000	P	S	0	1	S	0	2	X	0	3	
21	1	P	0	9	8	5,000	P	S	0	1	S	0	2	X	0	3	
21	2	P	0	9	9	5,000	P	S	0	1	S	0	2	X	0	3	
21	3	P	1	0	1	5,000	P	S	0	1	S	0	2	X	0	3	
21	4	P	1	0	2	5,000	P	S	0	1	S	0	2	X	0	3	
21	5	P	1	0	3	5,000	P	S	0	1	S	0	2	X	0	3	
21	6	P	1	0	4	5,000	P	S	0	1	S	0	2	X	0	3	
21	7	P	1	0	5	5,000	P	S	0	1	S	0	2	X	0	3	
21	8	P	1	0	8	5,000	P	S	0	1	S	0	2	X	0	3	
21	9	P	1	0	9	5,000	P	S	0	1	S	0	2	X	0	3	
22	0	P	1	1	0	5,000	P	S	0	1	S	0	2	X	0	3	
22	1	P	1	1	3	5,000	P	S	0	1	S	0	2	X	0	3	
22	2	P	1	1	4	5,000	P	S	0	1	S	0	2	X	0	3	
22	3	P	1	1	5	5,000	P	S	0	1	S	0	2	X	0	3	
22	4	P	1	1	6	5,000	P	S	0	1	S	0	2	X	0	3	
22	5	P	1	1	8	5,000	P	S	0	1	S	0	2	X	0	3	
22	6	P	1	1	9	5,000	P	S	0	1	S	0	2	X	0	3	
22	7	P	1	2	0	5,000	P	S	0	1	S	0	2	X	0	3	
22	8	P	1	2	1	5,000	P	S	0	1	S	0	2	X	0	3	
22	9	P	1	2	3	5,000	P	S	0	1	S	0	2	X	0	3	
23	0	U	0	0	1	5,000	P	S	0	1	S	0	2	X	0	3	
23	1	U	0	0	2	5,000	P	S	0	1	S	0	2	X	0	3	
23	2	U	0	0	3	5,000	P	S	0	1	S	0	2	X	0	3	
23	3	U	0	0	4	5,000	P	S	0	1	S	0	2	X	0	3	
23	4	U	0	0	5	5,000	P	S	0	1	S	0	2	X	0	3	

10. Description of Hazardous Wastes (Continued. Use this Additional Sheet (s) as necessary; number as 5a, etc.)

Line Number	A. EPA Hazardous Waste No. (Enter code)				B. Estimated Annual Quantity of Waste	C. Unit of Measure (Enter code)	E. PROCESSES										(2) PROCESS DESCRIPTION (If a code is not entered in E(1))
	(1) PROCESS CODES (Enter code)																
23	5	U	0	0	7	5,000	P	S	0	1	S	0	2	X	0	3	
23	6	U	0	0	8	5,000	P	S	0	1	S	0	2	X	0	3	
23	7	U	0	0	9	5,000	P	S	0	1	S	0	2	X	0	3	
23	8	U	0	1	0	5,000	P	S	0	1	S	0	2	X	0	3	
23	9	U	0	1	1	5,000	P	S	0	1	S	0	2	X	0	3	
24	0	U	0	1	2	5,000	P	S	0	1	S	0	2	X	0	3	
24	1	U	0	1	4	5,000	P	S	0	1	S	0	2	X	0	3	
24	2	U	0	1	5	5,000	P	S	0	1	S	0	2	X	0	3	
24	3	U	0	1	6	5,000	P	S	0	1	S	0	2	X	0	3	
24	4	U	0	1	7	5,000	P	S	0	1	S	0	2	X	0	3	
24	5	U	0	1	8	5,000	P	S	0	1	S	0	2	X	0	3	
24	6	U	0	1	9	5,000	P	S	0	1	S	0	2	X	0	3	
24	7																Intentionally blank
24	8	U	0	2	2	5,000	P	S	0	1	S	0	2	X	0	3	
24	9	U	0	2	4	5,000	P	S	0	1	S	0	2	X	0	3	
25	0	U	0	2	5	5,000	P	S	0	1	S	0	2	X	0	3	
25	1	U	0	2	6	5,000	P	S	0	1	S	0	2	X	0	3	
25	2	U	0	2	7	5,000	P	S	0	1	S	0	2	X	0	3	
25	3	U	0	2	8	5,000	P	S	0	1	S	0	2	X	0	3	
25	4	U	0	2	9	5,000	P	S	0	1	S	0	2	X	0	3	
25	5	U	0	3	0	5,000	P	S	0	1	S	0	2	X	0	3	
25	6	U	0	3	1	5,000	P	S	0	1	S	0	2	X	0	3	
25	7	U	0	3	2	5,000	P	S	0	1	S	0	2	X	0	3	
25	8	U	0	3	4	5,000	P	S	0	1	S	0	2	X	0	3	
25	9	U	0	3	5	5,000	P	S	0	1	S	0	2	X	0	3	
26	0	U	0	3	6	5,000	P	S	0	1	S	0	2	X	0	3	
26	1	U	0	3	7	5,000	P	S	0	1	S	0	2	X	0	3	
26	2	U	0	3	8	5,000	P	S	0	1	S	0	2	X	0	3	
26	3	U	0	3	9	5,000	P	S	0	1	S	0	2	X	0	3	
26	4	U	0	4	1	5,000	P	S	0	1	S	0	2	X	0	3	
26	5	U	0	4	2	5,000	P	S	0	1	S	0	2	X	0	3	
26	6	U	0	4	3	5,000	P	S	0	1	S	0	2	X	0	3	
26	7	U	0	4	4	5,000	P	S	0	1	S	0	2	X	0	3	
26	8	U	0	4	5	5,000	P	S	0	1	S	0	2	X	0	3	
26	9	U	0	4	6	5,000	P	S	0	1	S	0	2	X	0	3	
27	0	U	0	4	7	5,000	P	S	0	1	S	0	2	X	0	3	
27	1	U	0	4	8	5,000	P	S	0	1	S	0	2	X	0	3	
27	2	U	0	4	9	5,000	P	S	0	1	S	0	2	X	0	3	
27	3	U	0	5	0	5,000	P	S	0	1	S	0	2	X	0	3	

10. Description of Hazardous Wastes (Continued. Use this Additional Sheet (s) as necessary; number as 5a, etc.)

Line Number	A. EPA Hazardous Waste No. (Enter code)					B. Estimated Annual Quantity of Waste	C. Unit of Measure (Enter code)	E. PROCESSES									
	(1) PROCESS CODES (Enter code)										(2) PROCESS DESCRIPTION (If a code is not entered in E(1))						
	S	0	1	S	0			2	X	0		3					
27	4	U	0	5	1	5,000	P	S	0	1	S	0	2	X	0	3	
27	5	U	0	5	2	5,000	P	S	0	1	S	0	2	X	0	3	
27	6	U	0	5	3	5,000	P	S	0	1	S	0	2	X	0	3	
27	7	U	0	5	5	5,000	P	S	0	1	S	0	2	X	0	3	
27	8	U	0	5	6	5,000	P	S	0	1	S	0	2	X	0	3	
27	9	U	0	5	7	5,000	P	S	0	1	S	0	2	X	0	3	
28	0	U	0	5	8	5,000	P	S	0	1	S	0	2	X	0	3	
28	1	U	0	5	9	5,000	P	S	0	1	S	0	2	X	0	3	
28	2	U	0	6	0	5,000	P	S	0	1	S	0	2	X	0	3	
28	3	U	0	6	1	5,000	P	S	0	1	S	0	2	X	0	3	
28	4	U	0	6	2	5,000	P	S	0	1	S	0	2	X	0	3	
28	5	U	0	6	3	5,000	P	S	0	1	S	0	2	X	0	3	
28	6	U	0	6	4	5,000	P	S	0	1	S	0	2	X	0	3	
28	7	U	0	6	6	5,000	P	S	0	1	S	0	2	X	0	3	
28	8	U	0	6	7	5,000	P	S	0	1	S	0	2	X	0	3	
28	9	U	0	6	8	5,000	P	S	0	1	S	0	2	X	0	3	
29	0	U	0	6	9	5,000	P	S	0	1	S	0	2	X	0	3	
29	1	U	0	7	0	5,000	P	S	0	1	S	0	2	X	0	3	
29	2	U	0	7	1	5,000	P	S	0	1	S	0	2	X	0	3	
29	3	U	0	7	2	5,000	P	S	0	1	S	0	2	X	0	3	
29	4	U	0	7	3	5,000	P	S	0	1	S	0	2	X	0	3	
29	5	U	0	7	4	5,000	P	S	0	1	S	0	2	X	0	3	
29	6	U	0	7	5	5,000	P	S	0	1	S	0	2	X	0	3	
29	7	U	0	7	6	5,000	P	S	0	1	S	0	2	X	0	3	
29	8	U	0	7	7	5,000	P	S	0	1	S	0	2	X	0	3	
29	9	U	0	7	8	5,000	P	S	0	1	S	0	2	X	0	3	
30	0	U	0	7	9	5,000	P	S	0	1	S	0	2	X	0	3	
30	1	U	0	8	0	5,000	P	S	0	1	S	0	2	X	0	3	
30	2	U	0	8	1	5,000	P	S	0	1	S	0	2	X	0	3	
30	3	U	0	8	2	5,000	P	S	0	1	S	0	2	X	0	3	
30	4	U	0	8	3	5,000	P	S	0	1	S	0	2	X	0	3	
30	5	U	0	8	4	5,000	P	S	0	1	S	0	2	X	0	3	
30	6	U	0	8	5	5,000	P	S	0	1	S	0	2	X	0	3	
30	7	U	0	8	6	5,000	P	S	0	1	S	0	2	X	0	3	
30	8	U	0	8	7	5,000	P	S	0	1	S	0	2	X	0	3	
30	9	U	0	8	8	5,000	P	S	0	1	S	0	2	X	0	3	
31	0	U	0	8	9	5,000	P	S	0	1	S	0	2	X	0	3	
31	1	U	0	9	0	5,000	P	S	0	1	S	0	2	X	0	3	
31	2	U	0	9	1	5,000	P	S	0	1	S	0	2	X	0	3	

10. Description of Hazardous Wastes (Continued. Use this Additional Sheet (s) as necessary; number as 5a, etc.)

Line Number	A. EPA Hazardous Waste No. (Enter code)				B. Estimated Annual Quantity of Waste	C. Unit of Measure (Enter code)	E. PROCESSES										
	(1) PROCESS CODES (Enter code)										(2) PROCESS DESCRIPTION (If a code is not entered in E(1))						
	S	0	1	S			0	2	X	0		3					
31	3	U	0	9	2	5,000	P	S	0	1	S	0	2	X	0	3	
31	4	U	0	9	3	5,000	P	S	0	1	S	0	2	X	0	3	
31	5	U	0	9	4	5,000	P	S	0	1	S	0	2	X	0	3	
31	6	U	0	9	5	5,000	P	S	0	1	S	0	2	X	0	3	
31	7	U	0	9	7	5,000	P	S	0	1	S	0	2	X	0	3	
31	8	U	0	9	8	5,000	P	S	0	1	S	0	2	X	0	3	
31	9	U	0	9	9	5,000	P	S	0	1	S	0	2	X	0	3	
32	0	U	1	0	1	5,000	P	S	0	1	S	0	2	X	0	3	
32	1	U	1	0	2	5,000	P	S	0	1	S	0	2	X	0	3	
32	2	U	1	0	3	5,000	P	S	0	1	S	0	2	X	0	3	
32	3	U	1	0	5	5,000	P	S	0	1	S	0	2	X	0	3	
32	4	U	1	0	6	5,000	P	S	0	1	S	0	2	X	0	3	
32	5	U	1	0	7	5,000	P	S	0	1	S	0	2	X	0	3	
32	6	U	1	0	8	5,000	P	S	0	1	S	0	2	X	0	3	
32	7	U	1	0	9	5,000	P	S	0	1	S	0	2	X	0	3	
32	8	U	1	1	0	5,000	P	S	0	1	S	0	2	X	0	3	
32	9	U	1	1	1	5,000	P	S	0	1	S	0	2	X	0	3	
33	0	U	1	1	2	5,000	P	S	0	1	S	0	2	X	0	3	
33	1	U	1	1	3	5,000	P	S	0	1	S	0	2	X	0	3	
33	2	U	1	1	4	5,000	P	S	0	1	S	0	2	X	0	3	
33	3	U	1	1	5	5,000	P	S	0	1	S	0	2	X	0	3	
33	4	U	1	1	6	5,000	P	S	0	1	S	0	2	X	0	3	
33	5	U	1	1	7	5,000	P	S	0	1	S	0	2	X	0	3	
33	6	U	1	1	8	5,000	P	S	0	1	S	0	2	X	0	3	
33	7	U	1	1	9	5,000	P	S	0	1	S	0	2	X	0	3	
33	8	U	1	2	0	5,000	P	S	0	1	S	0	2	X	0	3	
33	9	U	1	2	1	5,000	P	S	0	1	S	0	2	X	0	3	
34	0	U	1	2	2	5,000	P	S	0	1	S	0	2	X	0	3	
34	1	U	1	2	4	5,000	P	S	0	1	S	0	2	X	0	3	
34	2	U	1	2	5	5,000	P	S	0	1	S	0	2	X	0	3	
34	3	U	1	2	6	5,000	P	S	0	1	S	0	2	X	0	3	
34	4	U	1	2	7	5,000	P	S	0	1	S	0	2	X	0	3	
34	5	U	1	2	8	5,000	P	S	0	1	S	0	2	X	0	3	
34	6	U	1	2	9	5,000	P	S	0	1	S	0	2	X	0	3	
34	7	U	1	3	0	5,000	P	S	0	1	S	0	2	X	0	3	
34	8	U	1	3	1	5,000	P	S	0	1	S	0	2	X	0	3	
34	9	U	1	3	2	5,000	P	S	0	1	S	0	2	X	0	3	
35	0	U	1	3	5	5,000	P	S	0	1	S	0	2	X	0	3	
35	1	U	1	3	6	5,000	P	S	0	1	S	0	2	X	0	3	

10. Description of Hazardous Wastes (Continued. Use this Additional Sheet (s) as necessary; number as 5a, etc.)

Line Number	A.					B. Estimated Annual Quantity of Waste	C. Unit of Measure (Enter code)	E. PROCESSES										(2) PROCESS DESCRIPTION (If a code is not entered in E(1))
	EPA Hazardous Waste No. (Enter code)							(1) PROCESS CODES (Enter code)										
35	2	U	1	3	7	5,000	P	S	0	1	S	0	2	X	0	3		
35	3	U	1	3	8	5,000	P	S	0	1	S	0	2	X	0	3		
35	4	U	1	4	0	5,000	P	S	0	1	S	0	2	X	0	3		
35	5	U	1	4	1	5,000	P	S	0	1	S	0	2	X	0	3		
35	6	U	1	4	2	5,000	P	S	0	1	S	0	2	X	0	3		
35	7	U	1	4	3	5,000	P	S	0	1	S	0	2	X	0	3		
35	8	U	1	4	4	5,000	P	S	0	1	S	0	2	X	0	3		
35	9	U	1	4	5	5,000	P	S	0	1	S	0	2	X	0	3		
36	0	U	1	4	6	5,000	P	S	0	1	S	0	2	X	0	3		
36	1	U	1	4	7	5,000	P	S	0	1	S	0	2	X	0	3		
36	2	U	1	4	8	5,000	P	S	0	1	S	0	2	X	0	3		
36	3	U	1	4	9	5,000	P	S	0	1	S	0	2	X	0	3		
36	4	U	1	5	0	5,000	P	S	0	1	S	0	2	X	0	3		
36	5	U	1	5	1	5,000	P	S	0	1	S	0	2	X	0	3		
36	6	U	1	5	2	5,000	P	S	0	1	S	0	2	X	0	3		
36	7	U	1	5	3	5,000	P	S	0	1	S	0	2	X	0	3		
36	8	U	1	5	4	5,000	P	S	0	1	S	0	2	X	0	3		
36	9	U	1	5	5	5,000	P	S	0	1	S	0	2	X	0	3		
37	0	U	1	5	6	5,000	P	S	0	1	S	0	2	X	0	3		
37	1	U	1	5	7	5,000	P	S	0	1	S	0	2	X	0	3		
37	2	U	1	5	8	5,000	P	S	0	1	S	0	2	X	0	3		
37	3	U	1	5	9	5,000	P	S	0	1	S	0	2	X	0	3		
37	4	U	1	6	1	5,000	P	S	0	1	S	0	2	X	0	3		
37	5	U	1	6	2	5,000	P	S	0	1	S	0	2	X	0	3		
37	6	U	1	6	3	5,000	P	S	0	1	S	0	2	X	0	3		
37	7	U	1	6	4	5,000	P	S	0	1	S	0	2	X	0	3		
37	8	U	1	6	5	5,000	P	S	0	1	S	0	2	X	0	3		
37	9	U	1	6	6	5,000	P	S	0	1	S	0	2	X	0	3		
38	0	U	1	6	7	5,000	P	S	0	1	S	0	2	X	0	3		
38	1	U	1	6	8	5,000	P	S	0	1	S	0	2	X	0	3		
38	2	U	1	6	9	5,000	P	S	0	1	S	0	2	X	0	3		
38	3	U	1	7	0	5,000	P	S	0	1	S	0	2	X	0	3		
38	4	U	1	7	1	5,000	P	S	0	1	S	0	2	X	0	3		
38	5	U	1	7	2	5,000	P	S	0	1	S	0	2	X	0	3		
38	6	U	1	7	3	5,000	P	S	0	1	S	0	2	X	0	3		
38	7	U	1	7	4	5,000	P	S	0	1	S	0	2	X	0	3		
38	8	U	1	7	6	5,000	P	S	0	1	S	0	2	X	0	3		
38	9	U	1	7	7	5,000	P	S	0	1	S	0	2	X	0	3		
39	0	U	1	7	8	5,000	P	S	0	1	S	0	2	X	0	3		

10. Description of Hazardous Wastes (Continued. Use this Additional Sheet (s) as necessary; number as 5a, etc.)

Line Number	A. EPA Hazardous Waste No. (Enter code)				B. Estimated Annual Quantity of Waste	C. Unit of Measure (Enter code)	E. PROCESSES											
	(1) PROCESS CODES (Enter code)												(2) PROCESS DESCRIPTION (If a code is not entered in E(1))					
39	1	U	1	7	9	5,000	P	S	0	1	S	0	2	X	0	3		
39	2	U	1	8	0	5,000	P	S	0	1	S	0	2	X	0	3		
39	3	U	1	8	1	5,000	P	S	0	1	S	0	2	X	0	3		
39	4	U	1	8	2	5,000	P	S	0	1	S	0	2	X	0	3		
39	5	U	1	8	3	5,000	P	S	0	1	S	0	2	X	0	3		
39	6	U	1	8	4	5,000	P	S	0	1	S	0	2	X	0	3		
39	7	U	1	8	5	5,000	P	S	0	1	S	0	2	X	0	3		
39	8	U	1	8	6	5,000	P	S	0	1	S	0	2	X	0	3		
39	9	U	1	8	7	5,000	P	S	0	1	S	0	2	X	0	3		
40	0	U	1	8	8	5,000	P	S	0	1	S	0	2	X	0	3		
40	1	U	1	9	0	5,000	P	S	0	1	S	0	2	X	0	3		
40	2	U	1	9	1	5,000	P	S	0	1	S	0	2	X	0	3		
40	3	U	1	9	2	5,000	P	S	0	1	S	0	2	X	0	3		
40	4	U	1	9	3	5,000	P	S	0	1	S	0	2	X	0	3		
40	5	U	1	9	4	5,000	P	S	0	1	S	0	2	X	0	3		
40	6	U	1	9	6	5,000	P	S	0	1	S	0	2	X	0	3		
40	7	U	1	9	7	5,000	P	S	0	1	S	0	2	X	0	3		
40	8	U	2	0	0	5,000	P	S	0	1	S	0	2	X	0	3		
40	9	U	2	0	1	5,000	P	S	0	1	S	0	2	X	0	3		
41	0	U	2	0	2	5,000	P	S	0	1	S	0	2	X	0	3		
41	1	U	2	0	3	5,000	P	S	0	1	S	0	2	X	0	3		
41	2	U	2	0	4	5,000	P	S	0	1	S	0	2	X	0	3		
41	3	U	2	0	6	5,000	P	S	0	1	S	0	2	X	0	3		
41	4	U	2	0	7	5,000	P	S	0	1	S	0	2	X	0	3		
41	5	U	2	0	8	5,000	P	S	0	1	S	0	2	X	0	3		
41	6	U	2	0	9	5,000	P	S	0	1	S	0	2	X	0	3		
41	7	U	2	1	0	5,000	P	S	0	1	S	0	2	X	0	3		
41	8	U	2	1	1	5,000	P	S	0	1	S	0	2	X	0	3		
41	9	U	2	1	3	5,000	P	S	0	1	S	0	2	X	0	3		
42	0	U	2	1	4	5,000	P	S	0	1	S	0	2	X	0	3		
42	1	U	2	1	5	5,000	P	S	0	1	S	0	2	X	0	3		
42	2	U	2	1	6	5,000	P	S	0	1	S	0	2	X	0	3		
42	3	U	2	1	7	5,000	P	S	0	1	S	0	2	X	0	3		
42	4	U	2	1	8	5,000	P	S	0	1	S	0	2	X	0	3		
42	5	U	2	1	9	5,000	P	S	0	1	S	0	2	X	0	3		
42	6	U	2	2	0	5,000	P	S	0	1	S	0	2	X	0	3		
42	7	U	2	2	1	5,000	P	S	0	1	S	0	2	X	0	3		
42	8	U	2	2	2	5,000	P	S	0	1	S	0	2	X	0	3		
42	9	U	2	2	5	5,000	P	S	0	1	S	0	2	X	0	3		

10. Description of Hazardous Wastes (Continued. Use this Additional Sheet (s) as necessary; number as 5a, etc.)

Line Number	A.					B. Estimated Annual Quantity of Waste	C. Unit of Measure (Enter code)	E. PROCESSES										(2) PROCESS DESCRIPTION (If a code is not entered in E(1))
	EPA Hazardous Waste No. (Enter code)							(1) PROCESS CODES (Enter code)										
43	0	U	2	2	6	5,000	P	S	0	1	S	0	2	X	0	3		
44	1	U	2	2	7	5,000	P	S	0	1	S	0	2	X	0	3		
44	2	U	2	2	8	5,000	P	S	0	1	S	0	2	X	0	3		
44	3	U	2	3	5	5,000	P	S	0	1	S	0	2	X	0	3		
44	4	U	2	3	6	5,000	P	S	0	1	S	0	2	X	0	3		
44	5	U	2	3	7	5,000	P	S	0	1	S	0	2	X	0	3		
44	6	U	2	3	8	5,000	P	S	0	1	S	0	2	X	0	3		
44	7	U	2	3	9	5,000	P	S	0	1	S	0	2	X	0	3		
44	8	U	2	4	0	5,000	P	S	0	1	S	0	2	X	0	3		
44	9	U	2	4	3	5,000	P	S	0	1	S	0	2	X	0	3		
45	0	U	2	4	4	5,000	P	S	0	1	S	0	2	X	0	3		
45	1	U	2	4	6	5,000	P	S	0	1	S	0	2	X	0	3		
45	2	U	2	4	7	5,000	P	S	0	1	S	0	2	X	0	3		
45	3	U	2	4	8	5,000	P	S	0	1	S	0	2	X	0	3		
45	4	U	2	4	9	5,000	P	S	0	1	S	0	2	X	0	3		
45	5	U	3	2	8	5,000	P	S	0	1	S	0	2	X	0	3		
45	6	U	3	5	3	5,000	P	S	0	1	S	0	2	X	0	3		
45	7	U	3	5	9	5,000	P	S	0	1	S	0	2	X	0	3		
45	8																	
45	9																	
46	0																	
46	1																	
46	2																	
46	3																	
46	4																	
46	5																	
46	6																	
46	7																	
46	8																	
46	9																	
47	0																	
47	1																	
47	2																	
47	3																	
47	4																	
47	5																	
47	6																	
47	7																	
47	8																	

11. Map (See instructions on pages 25 and 26)

Attach to this application a topographic map, or other equivalent map, of the area extending to at least one mile beyond property boundaries. The map must show the outline of the facility, the location of each of its existing and proposed intake and discharge structures, each of its hazardous waste treatment, storage, or disposal facilities, and each well where it injects fluids underground. Include all springs, rivers and other surface water bodies in this map area. See instructions for precise requirements.

12. Facility Drawing (See instructions on page 26)

All existing facilities must include a scale drawing of the facility (see instructions for more detail).

13. Photographs (See instructions on page 26)

All existing facilities must include photographs (aerial or ground-level) that clearly delineate all existing structures; existing storage, treatment and disposal areas; and sites of future storage, treatment or disposal areas (see instructions for more detail).

14. Comments (See instructions on page 26)

ATTACHMENT A – Item 9 – Facility Owner Information

EPA ID NUMBER: AZD982441236

NAME OF FACILITY'S LEGAL OWNER (Owner Type P):

SIEMENS INDUSTRY, INC.
2523 MUTAHAR STREET
PARKER, ARIZONA 85344-4005
TELEPHONE: (928) 669-5758

CORPORATE HEADQUARTERS OF FACILITY'S LEGAL OWNER:

SIEMENS INDUSTRY, INC.
181 THORN HILL ROAD
WARRENDALE, PENNSYLVANIA 15086
TELEPHONE: (724) 772-1402


NAME OF PROPERTY OWNER (Owner Type I):

COLORADO RIVER INDIAN TRIBES
RT – 1, BOX 23 – B
PARKER, ARIZONA 85344
TELEPHONE: (928) 669-9211

ATTACHMENT B – Item 11 – Topographic Map


DRAWING NO. C-100604 SHEET 1 OF 2 (REV. 0)
TOPOGRAPHICAL MAP 1 – PLANT SITE

DRAWING NO. C-100604 SHEET 2 OF 2 (REV. 0)
TOPOGRAPHICAL MAP 2 – ADJACENT LANDS

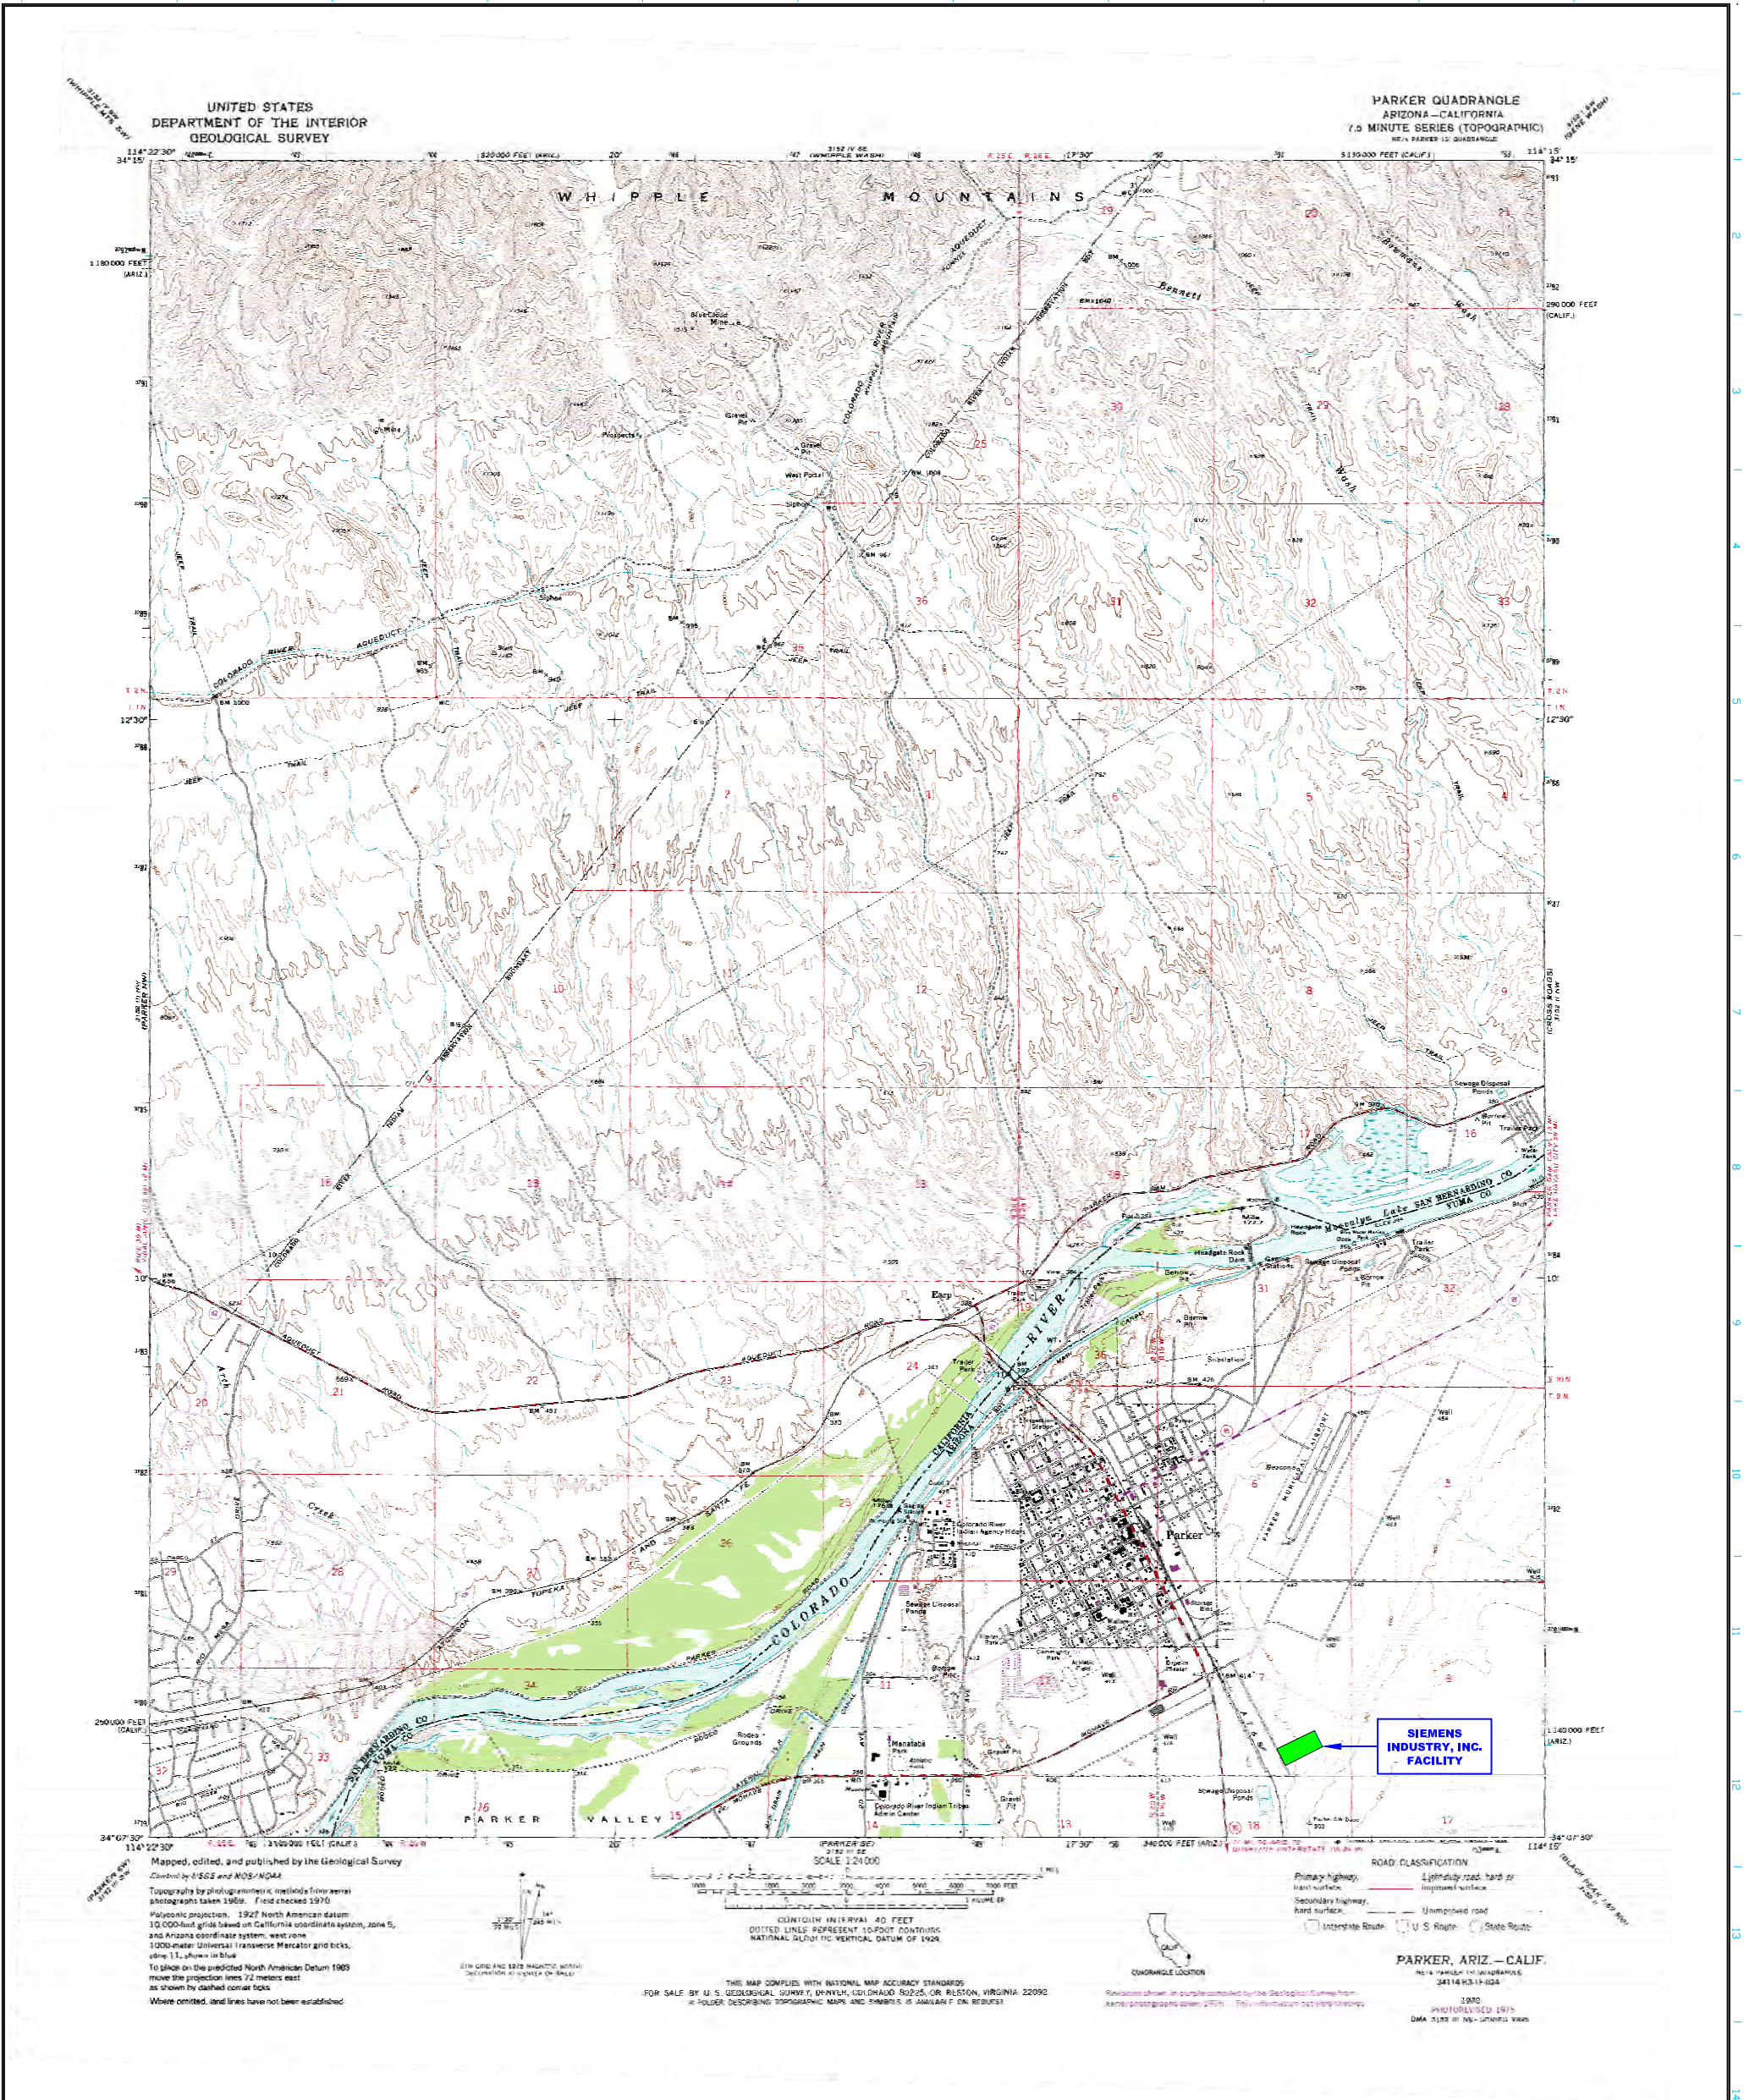

- NOTES:
1. SEE ATTACHED SIEMENS INDUSTRY, INC. DRAWING D-14789-02 FOR DETAILED LOCATION OF S01, S02, AND X03.
 2. THERE ARE NO INJECTION WELLS ASSOCIATED WITH THIS FACILITY.
 3. THERE ARE NO SPRINGS, DRINKING WATER WELLS, NOR SURFACE WATER BODIES LOCATED WITHIN 1/4 MILE OF THIS FACILITY.

					CUSTOMER: SIEMENS INDUSTRY, INC.		SIEMENS INDUSTRY, INC. Parker, AZ				
					LOCATION: 2523 MUTAHAR ST. PARKER, AZ 85344						
					PLOT SCALE: AS NOTED		TITLE: U.S.G.S. SURVEY – PARKER, AZ TOPOGRAPHIC MAP				
					DO NOT SCALE DRAWING						
					THIS DRAWING IS THE PROPERTY OF SIEMENS AND CANNOT BE REPRODUCED OR DELIVERED TO OTHERS WITHOUT THE EXPRESS WRITTEN PERMISSION OF SIEMENS INDUSTRY, INC.						
1	3/15/12	NAME CHANGED TO SIEMENS INDUSTRY, INC.	JBE	KEM			PROJECT No.		DWG No. C-100604	SHEET No. 1 of 2	REV. 1
							DRAWN: JBE 1/22/07				
							CHK'D: KEM 1/22/07				
							ENG'R:				
REV.	DATE	REVISION DESCRIPTION		DRAWN	CHK'D	ENG'R					

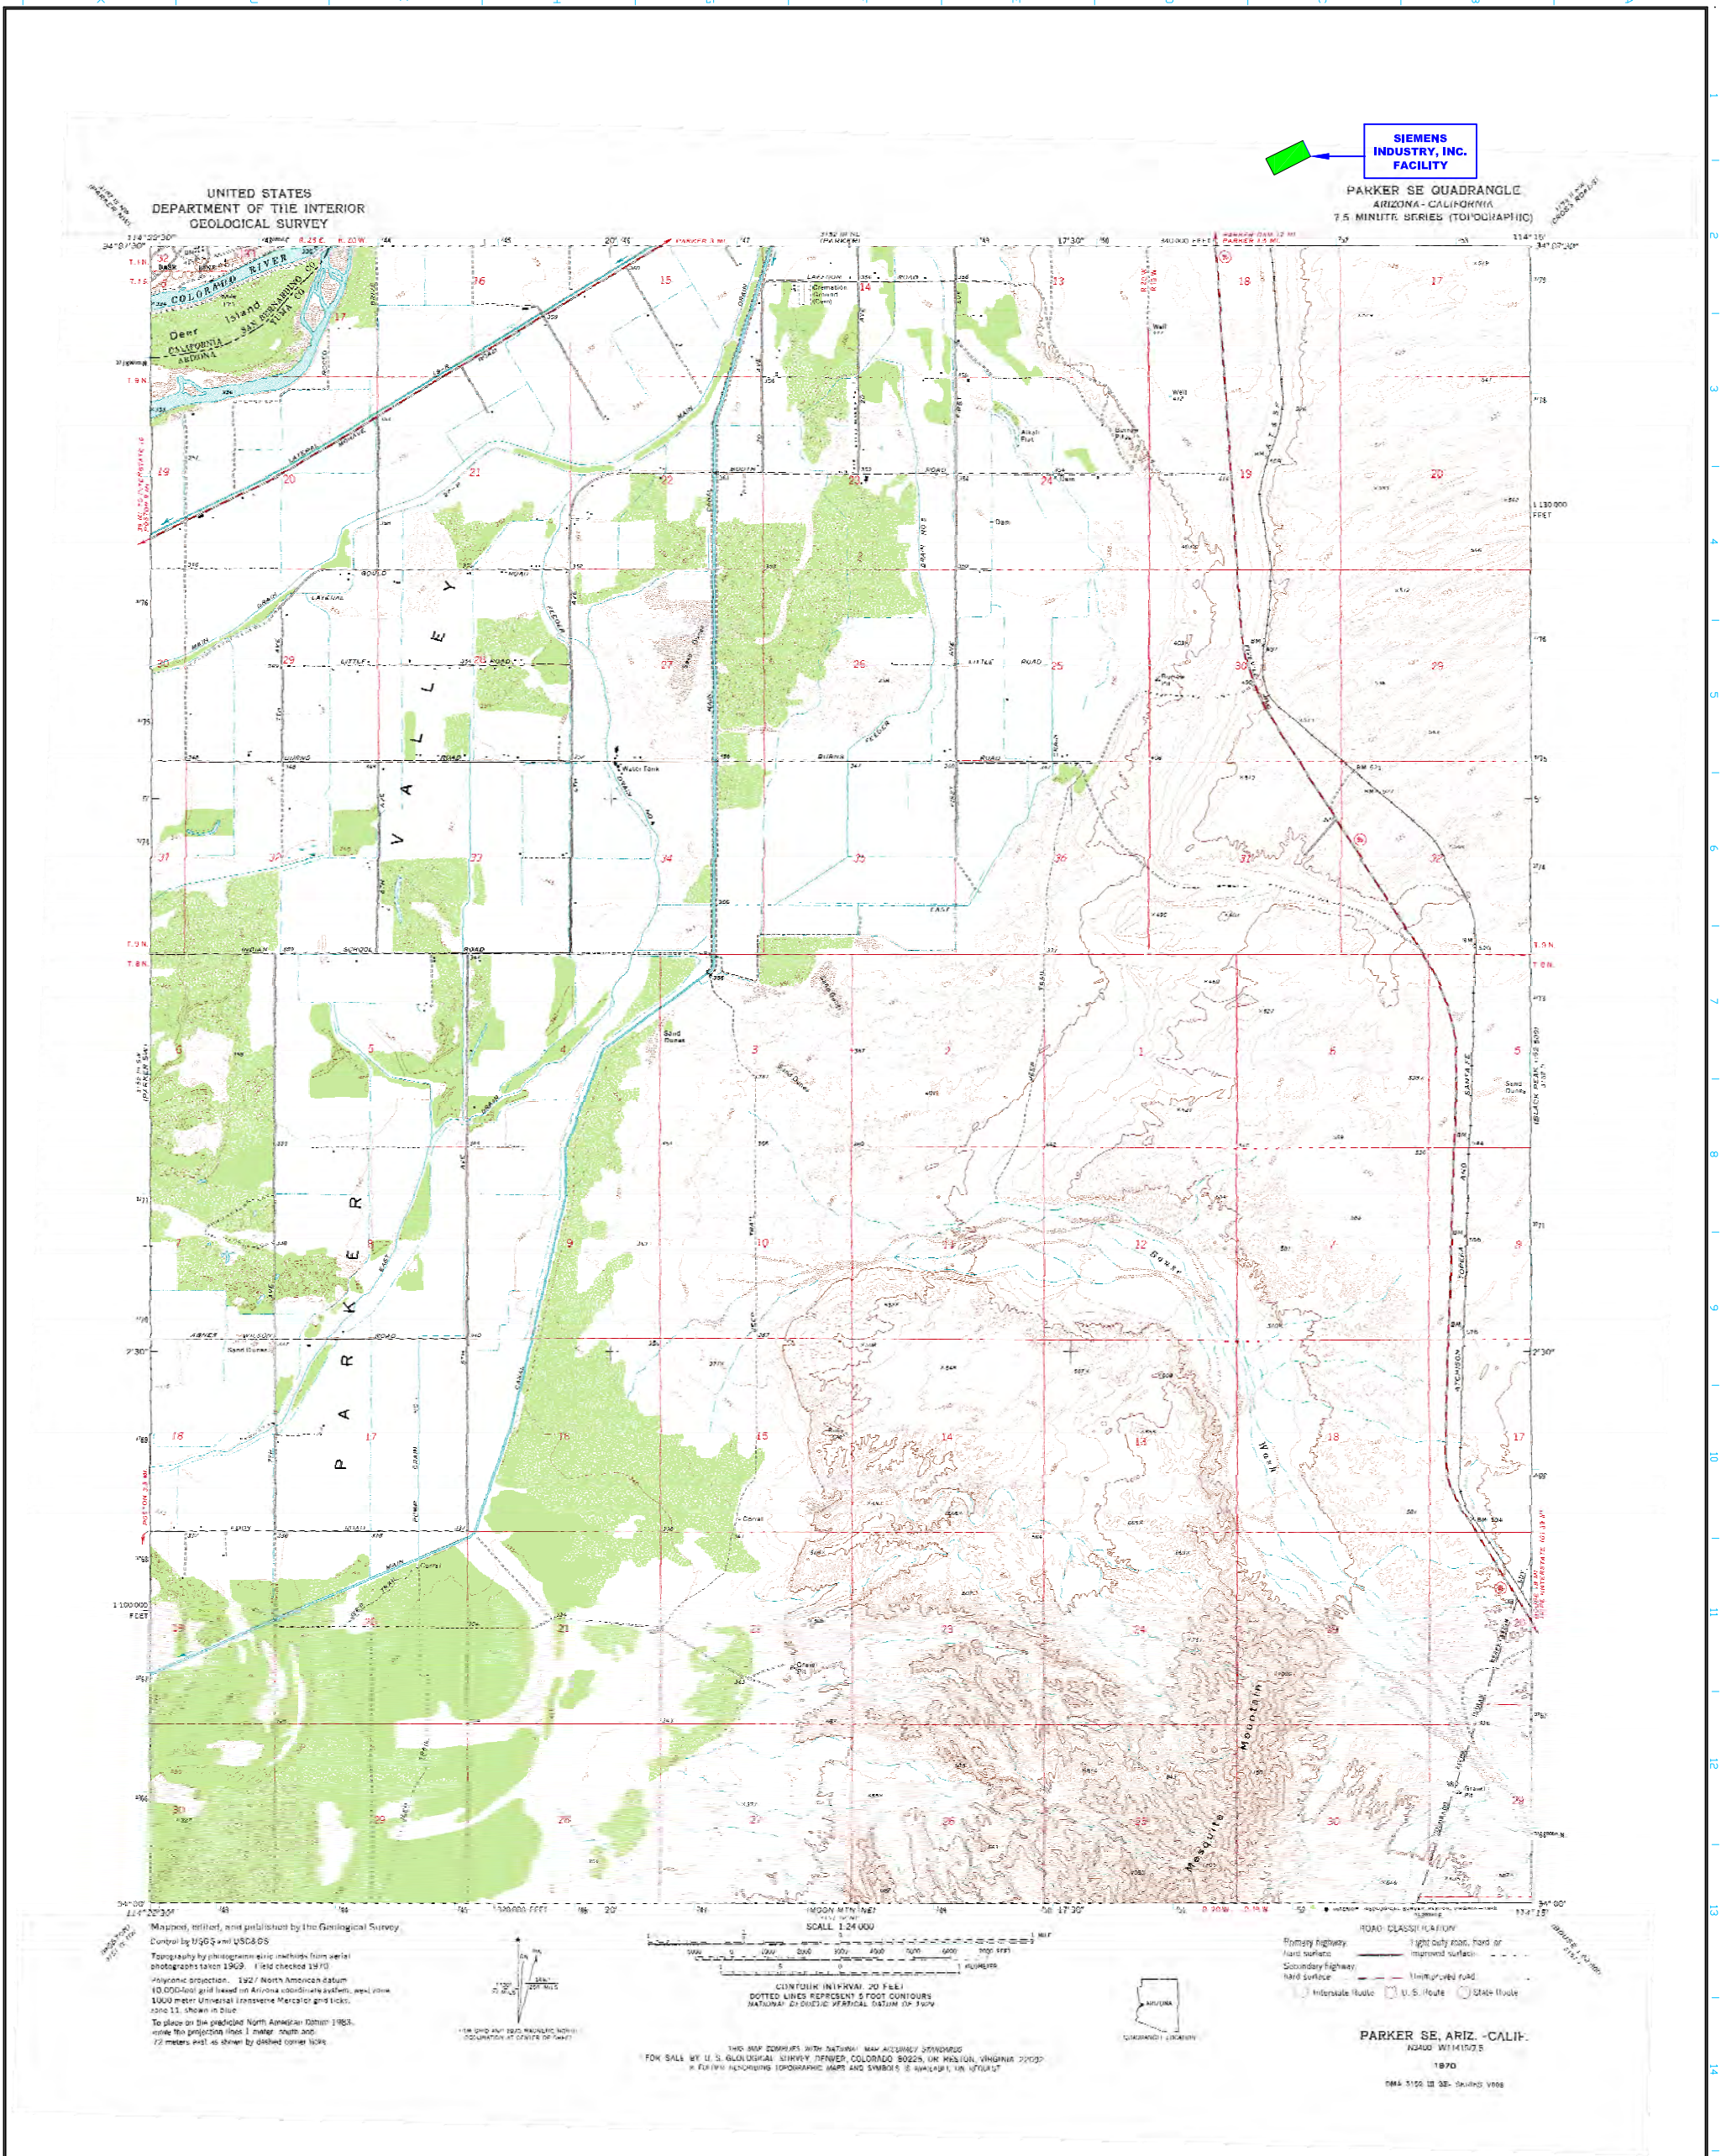

NOTES:

- SEE ATTACHED SIEMENS WATER TECHNOLOGIES CORP. DRAWING D-14789-02 FOR DETAILED LOCATION OF S01, S02, AND X03.
- THERE ARE NO INJECTION WELLS ASSOCIATED WITH THIS FACILITY.
- THERE ARE NO SPRINGS, DRINKING WATER WELLS, NOR SURFACE WATER BODIES LOCATED WITHIN 1/4 MILE OF THIS FACILITY.


1		3/15/12	NAME CHANGED TO SIEMENS INDUSTRY, INC.	JBE	KEM	THIS DRAWING IS THE PROPERTY OF SIEMENS AND CANNOT BE REPRODUCED OR DELIVERED TO OTHERS WITHOUT THE EXPRESS WRITTEN PERMISSION OF SIEMENS INDUSTRY, INC.	CUSTOMER: SIEMENS INDUSTRY, INC.		LOCATION: 2523 MUTAHAR ST. PARKER, AZ 85344	PROJECT No.	DRAWN: JBE 1/22/07	CHK'D: KEM 1/22/07	ENG'R:	DWG No. C-100604	SHEET No. 2 of 2	REV. 1
REV.	DATE	REVISION DESCRIPTION			DRAWN	CHK'D										

ATTACHMENT C – Item 12 – Facility Drawing

SCALE DRAWING OF PROPERTY LAYOUT

SCALE DRAWING OF FACILITY LAYOUT (EQUIPMENT LOCATION)


SCHEMATIC PROCESS FLOW DIAGRAM

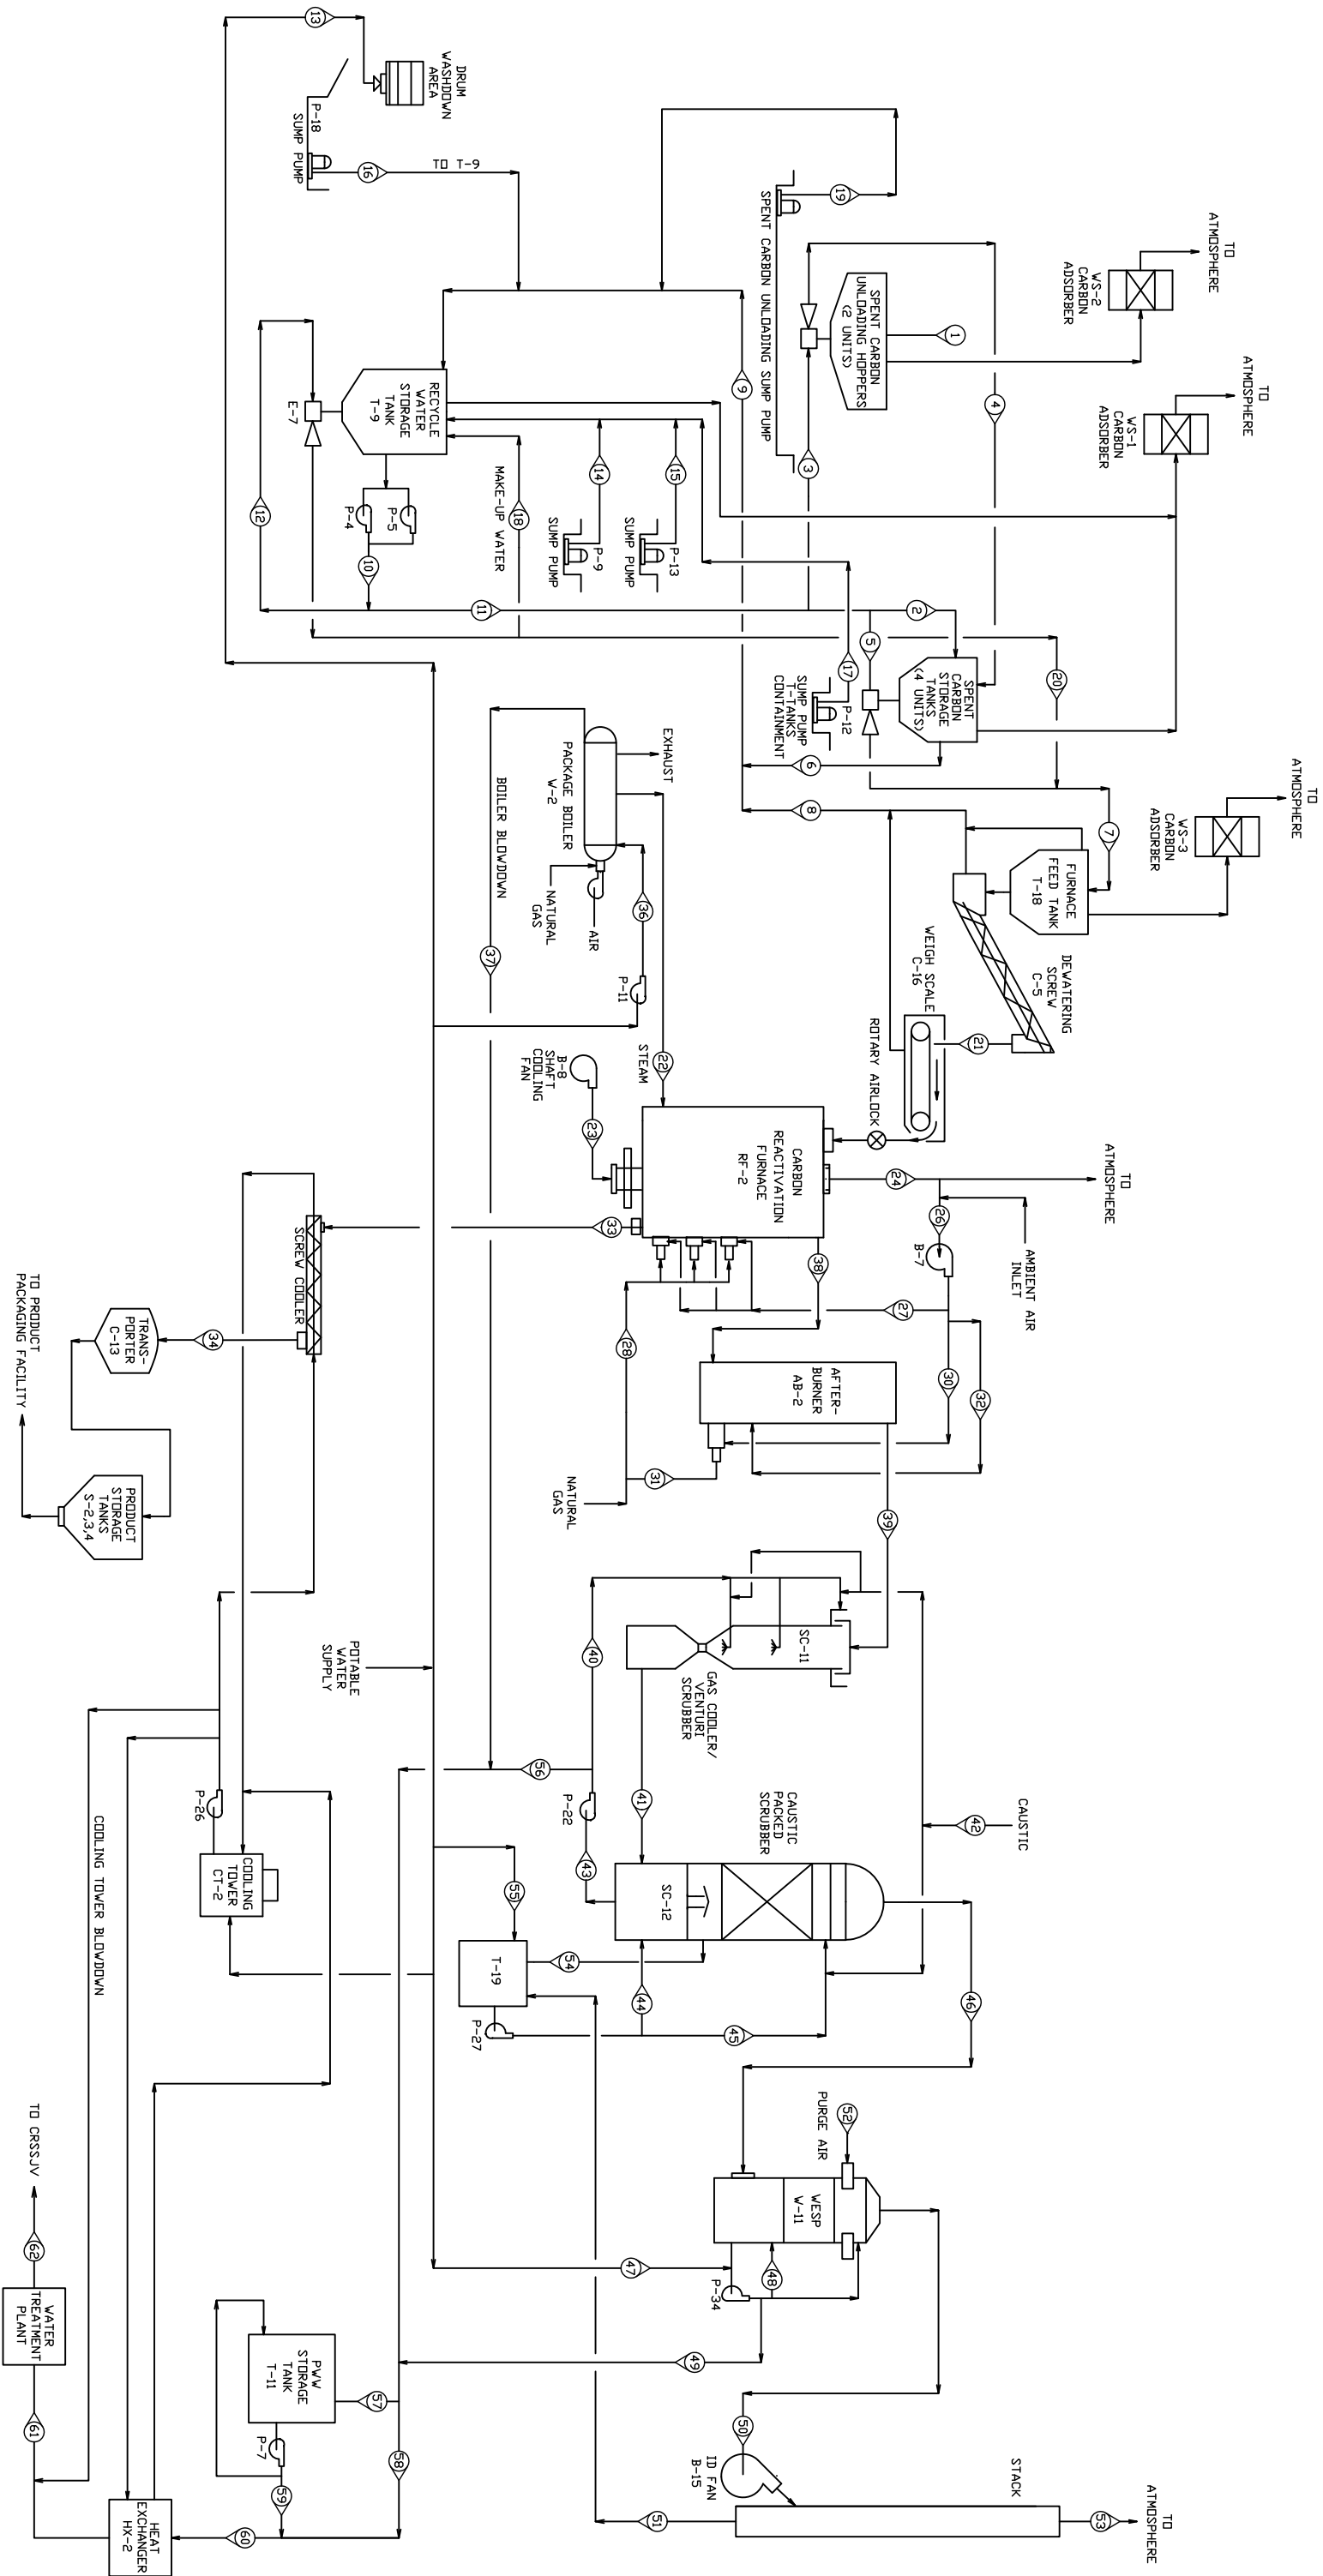

NOTES:

1. THIS DRAWING INCLUDES COMPONENTS OF THE FACILITY THAT ARE EXEMPT FROM PERMITTING UNDER VARIOUS PROVISIONS OF RCRA. INFORMATION IN THESE COMPONENTS IS PROVIDED FOR INFORMATIONAL PURPOSES ONLY AND THEY ARE NOT INTENDED TO BECOME REGULATED COMPONENTS OF THE HAZARDOUS WASTE FACILITY.

2	JBE	KEM		NAME CHANGED TO SIEMENS INDUSTRY	3-15-12
1	JBE	KEM		UPDATED FOR PERMIT SUBMITTAL	2-8-07
NO	DWN	CK'D	APP	REVISIONS	DATE
CBE CHAYOND-BARRY ENGINEERING CORP.					
400 Route 518 • P.O. Box 205 • Bloerburg, New Jersey 08504					
SIEMENS INDUSTRY, INC.					
2523 MUTAHAR STREET, PARKER, AZ 85344					
FACILITY PROCESS FLOW DIAGRAM					
DRAWN		CHECKED		APPROVED	
DATE		DATE		DATE	
AJV 11/27/96		KEM 11/27/96			
SCALE		DWG. NO.		REV.	
NONE		1525-PR-001		2	

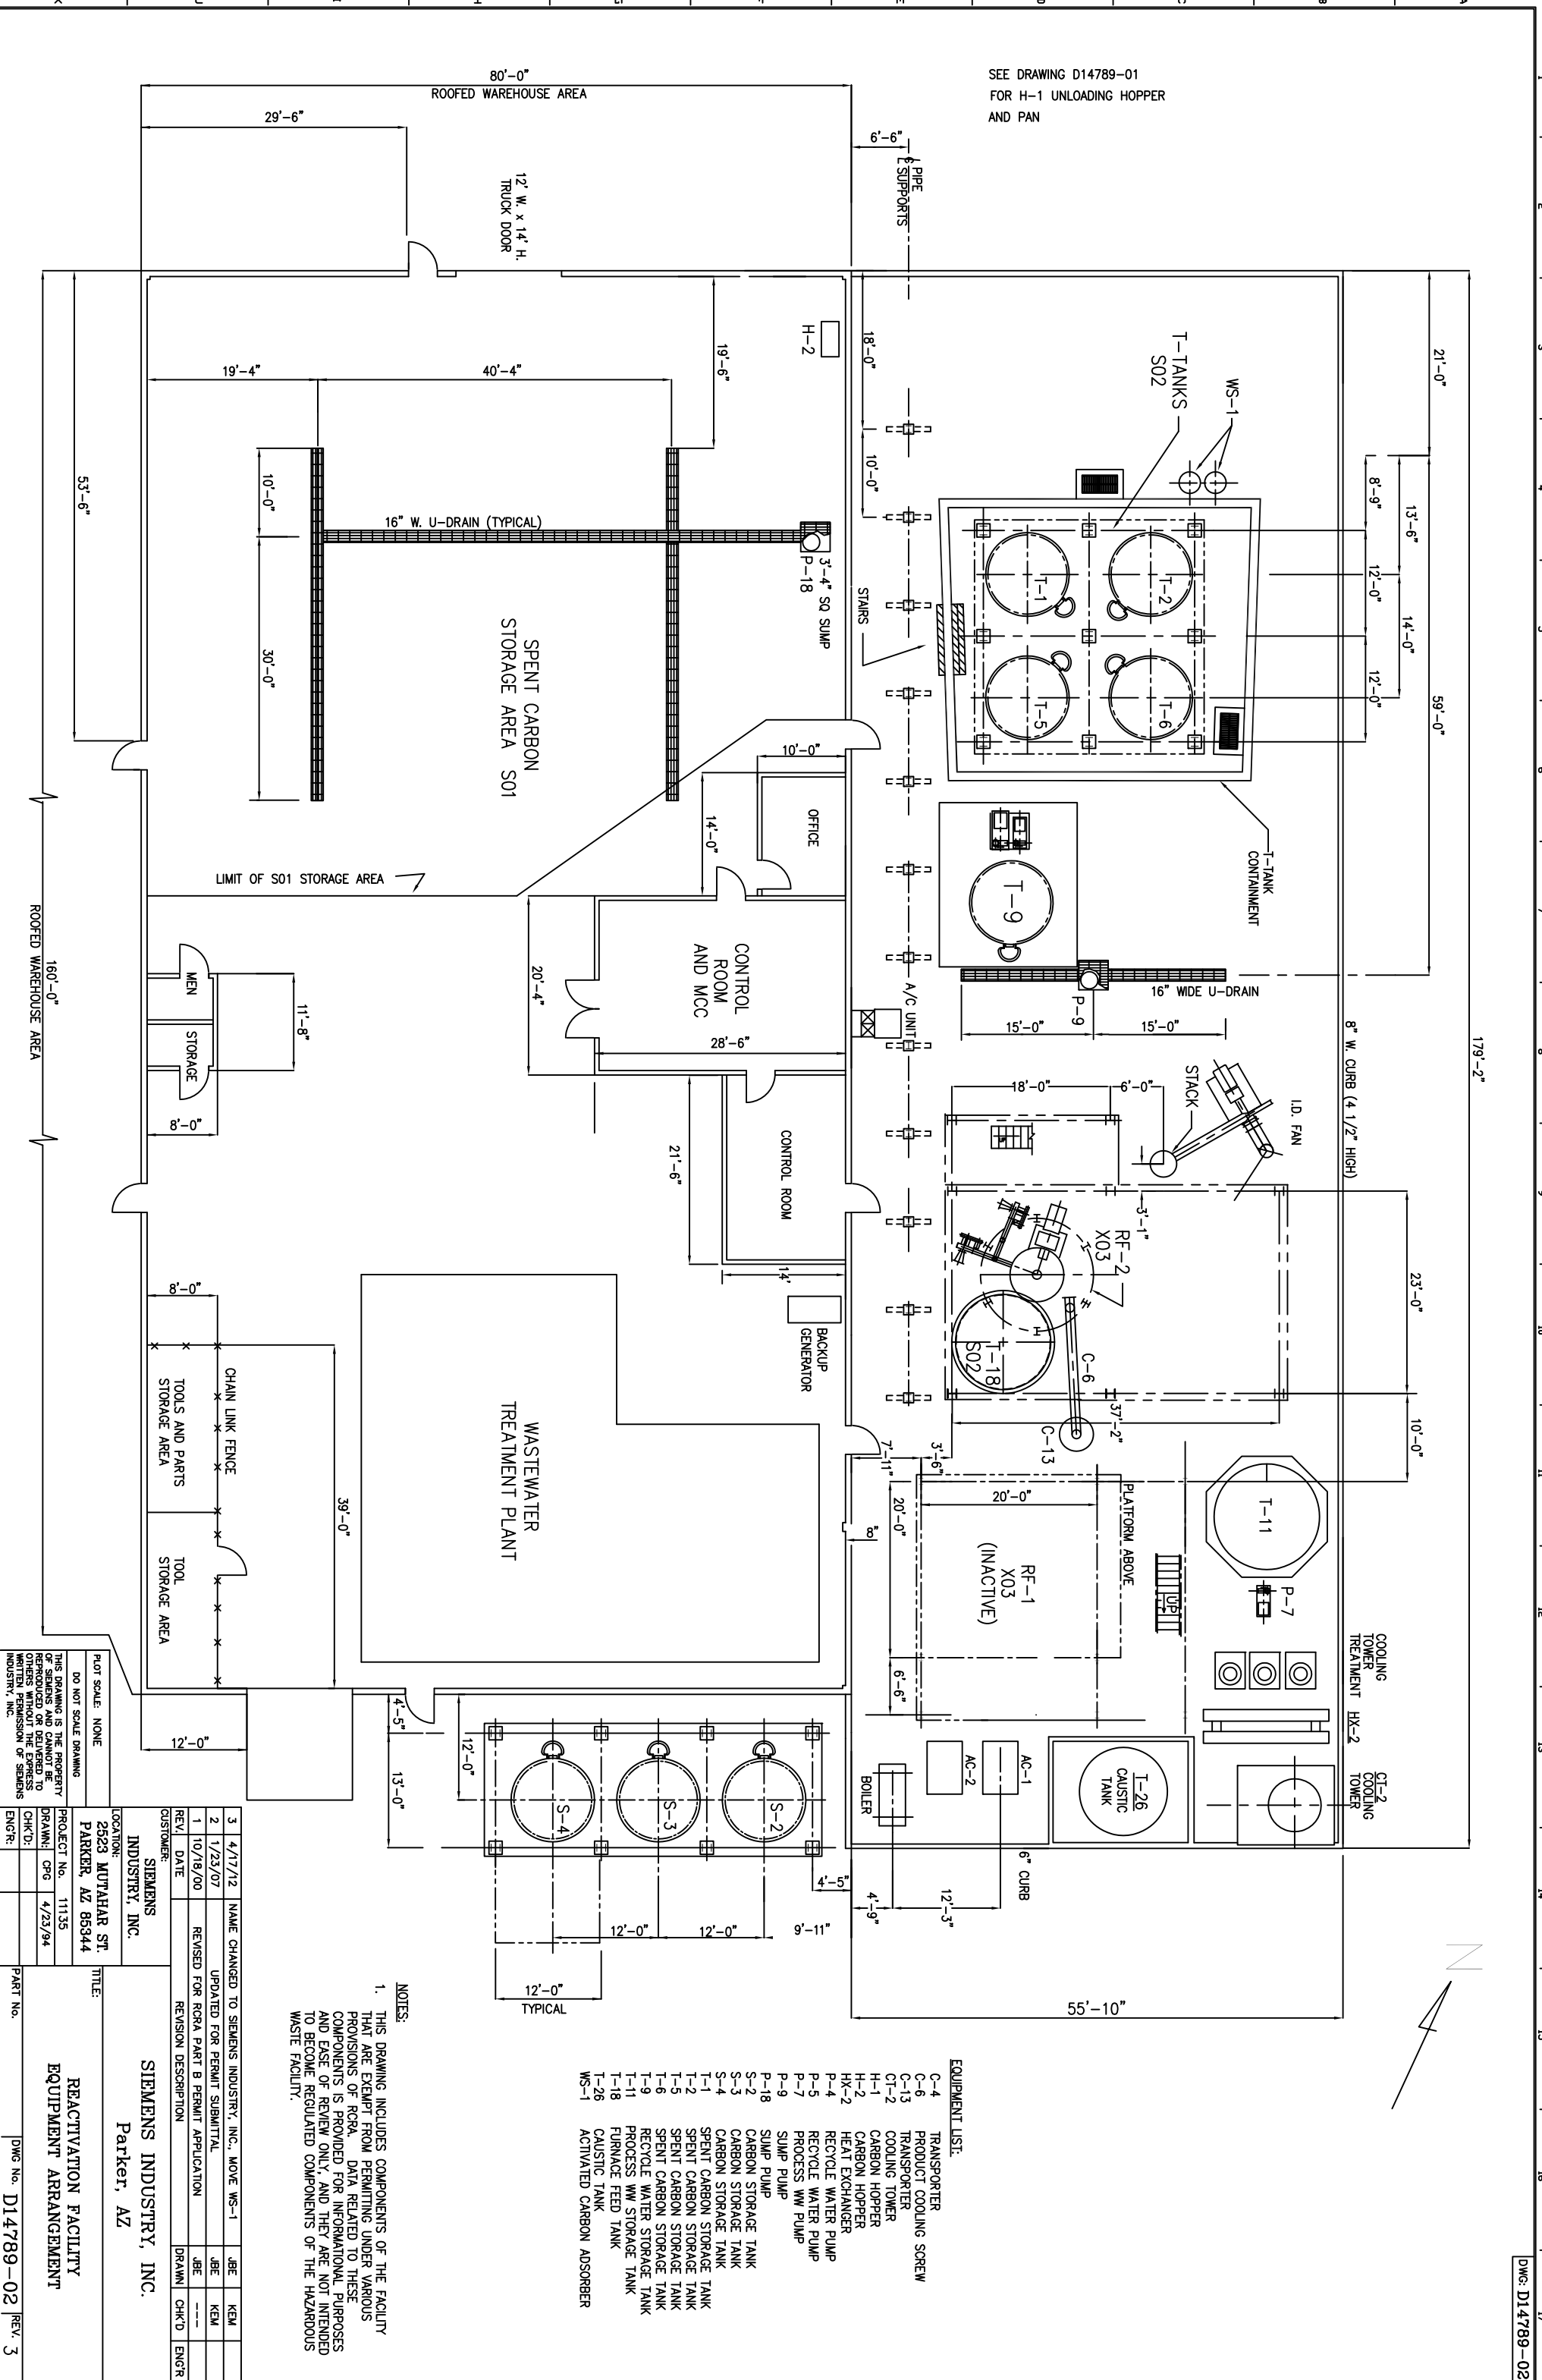

- EQUIPMENT LIST:
- C-4 TRANSPORTER
 - C-6 PRODUCT COOLING SCREW
 - C-13 TRANSPORTER
 - CT-2 COOLING TOWER
 - H-1 CARBON HOPPER
 - H-2 CARBON HOPPER
 - HX-2 HEAT EXCHANGER
 - P-4 RECYCLE WATER PUMP
 - P-5 RECYCLE WATER PUMP
 - P-7 PROCESS WW PUMP
 - P-9 SUMP PUMP
 - P-18 SUMP PUMP
 - S-2 CARBON STORAGE TANK
 - S-3 CARBON STORAGE TANK
 - S-4 CARBON STORAGE TANK
 - T-1 SPENT CARBON STORAGE TANK
 - T-2 SPENT CARBON STORAGE TANK
 - T-5 SPENT CARBON STORAGE TANK
 - T-6 SPENT CARBON STORAGE TANK
 - T-9 RECYCLE WATER STORAGE TANK
 - T-11 PROCESS WW STORAGE TANK
 - T-18 FURNACE FEED TANK
 - T-26 CAUSTIC TANK
 - WS-1 ACTIVATED CARBON ADSORBER

- NOTES:
- THIS DRAWING INCLUDES COMPONENTS OF THE FACILITY THAT ARE EXEMPT FROM PERMITTING UNDER VARIOUS PROVISIONS OF RCRA. DATA RELATED TO THESE COMPONENTS IS PROVIDED FOR INFORMATIONAL PURPOSES AND EASE OF REVIEW ONLY, AND THEY ARE NOT INTENDED TO BECOME REGULATED COMPONENTS OF THE HAZARDOUS WASTE FACILITY.

REVISIONS		APPROVALS	
REV.	DATE	BY	CHK'D
3	4/17/12	JBE	KEM
2	1/23/07	JBE	KEM
1	10/18/00	JBE	---
CUSTOMER:		SIEMENS INDUSTRY, INC.	
LOCATION:		2523 MUTAHAR ST.	
PROJECT No.		PARKER, AZ 85344	
DRAWN:		CPG	
CHK'D:		4/23/94	
ENGR:			
TITLE:		SIEMENS INDUSTRY, INC.	
		Parker, AZ	
PART No.		DWG No. D14789-02	
		REV. 3	

PLOT SCALE: NONE
DO NOT SCALE DRAWING
THIS DRAWING IS THE PROPERTY OF SIEMENS AND CANNOT BE REPRODUCED OR DELIVERED TO OTHERS WITHOUT THE EXPRESS WRITTEN PERMISSION OF SIEMENS INDUSTRIES, INC.

160'-0"
ROOFED WAREHOUSE AREA

80'-0"
ROOFED WAREHOUSE AREA

12' W. x 14' H.
TRUCK DOOR

19'-6"

40'-4"

19'-6"

16" W. U-DRAIN (TYPICAL)

10'-0"

30'-0"

53'-6"

160'-0"
ROOFED WAREHOUSE AREA

11'-8"

8'-0"

CHAIN LINK FENCE

TOOLS AND PARTS STORAGE AREA

TOOL STORAGE AREA


12'-0"

39'-0"

160'-0"
ROOFED WAREHOUSE AREA

SEE DRAWING D14789-01
FOR H-1 UNLOADING HOPPER
AND PAN

N

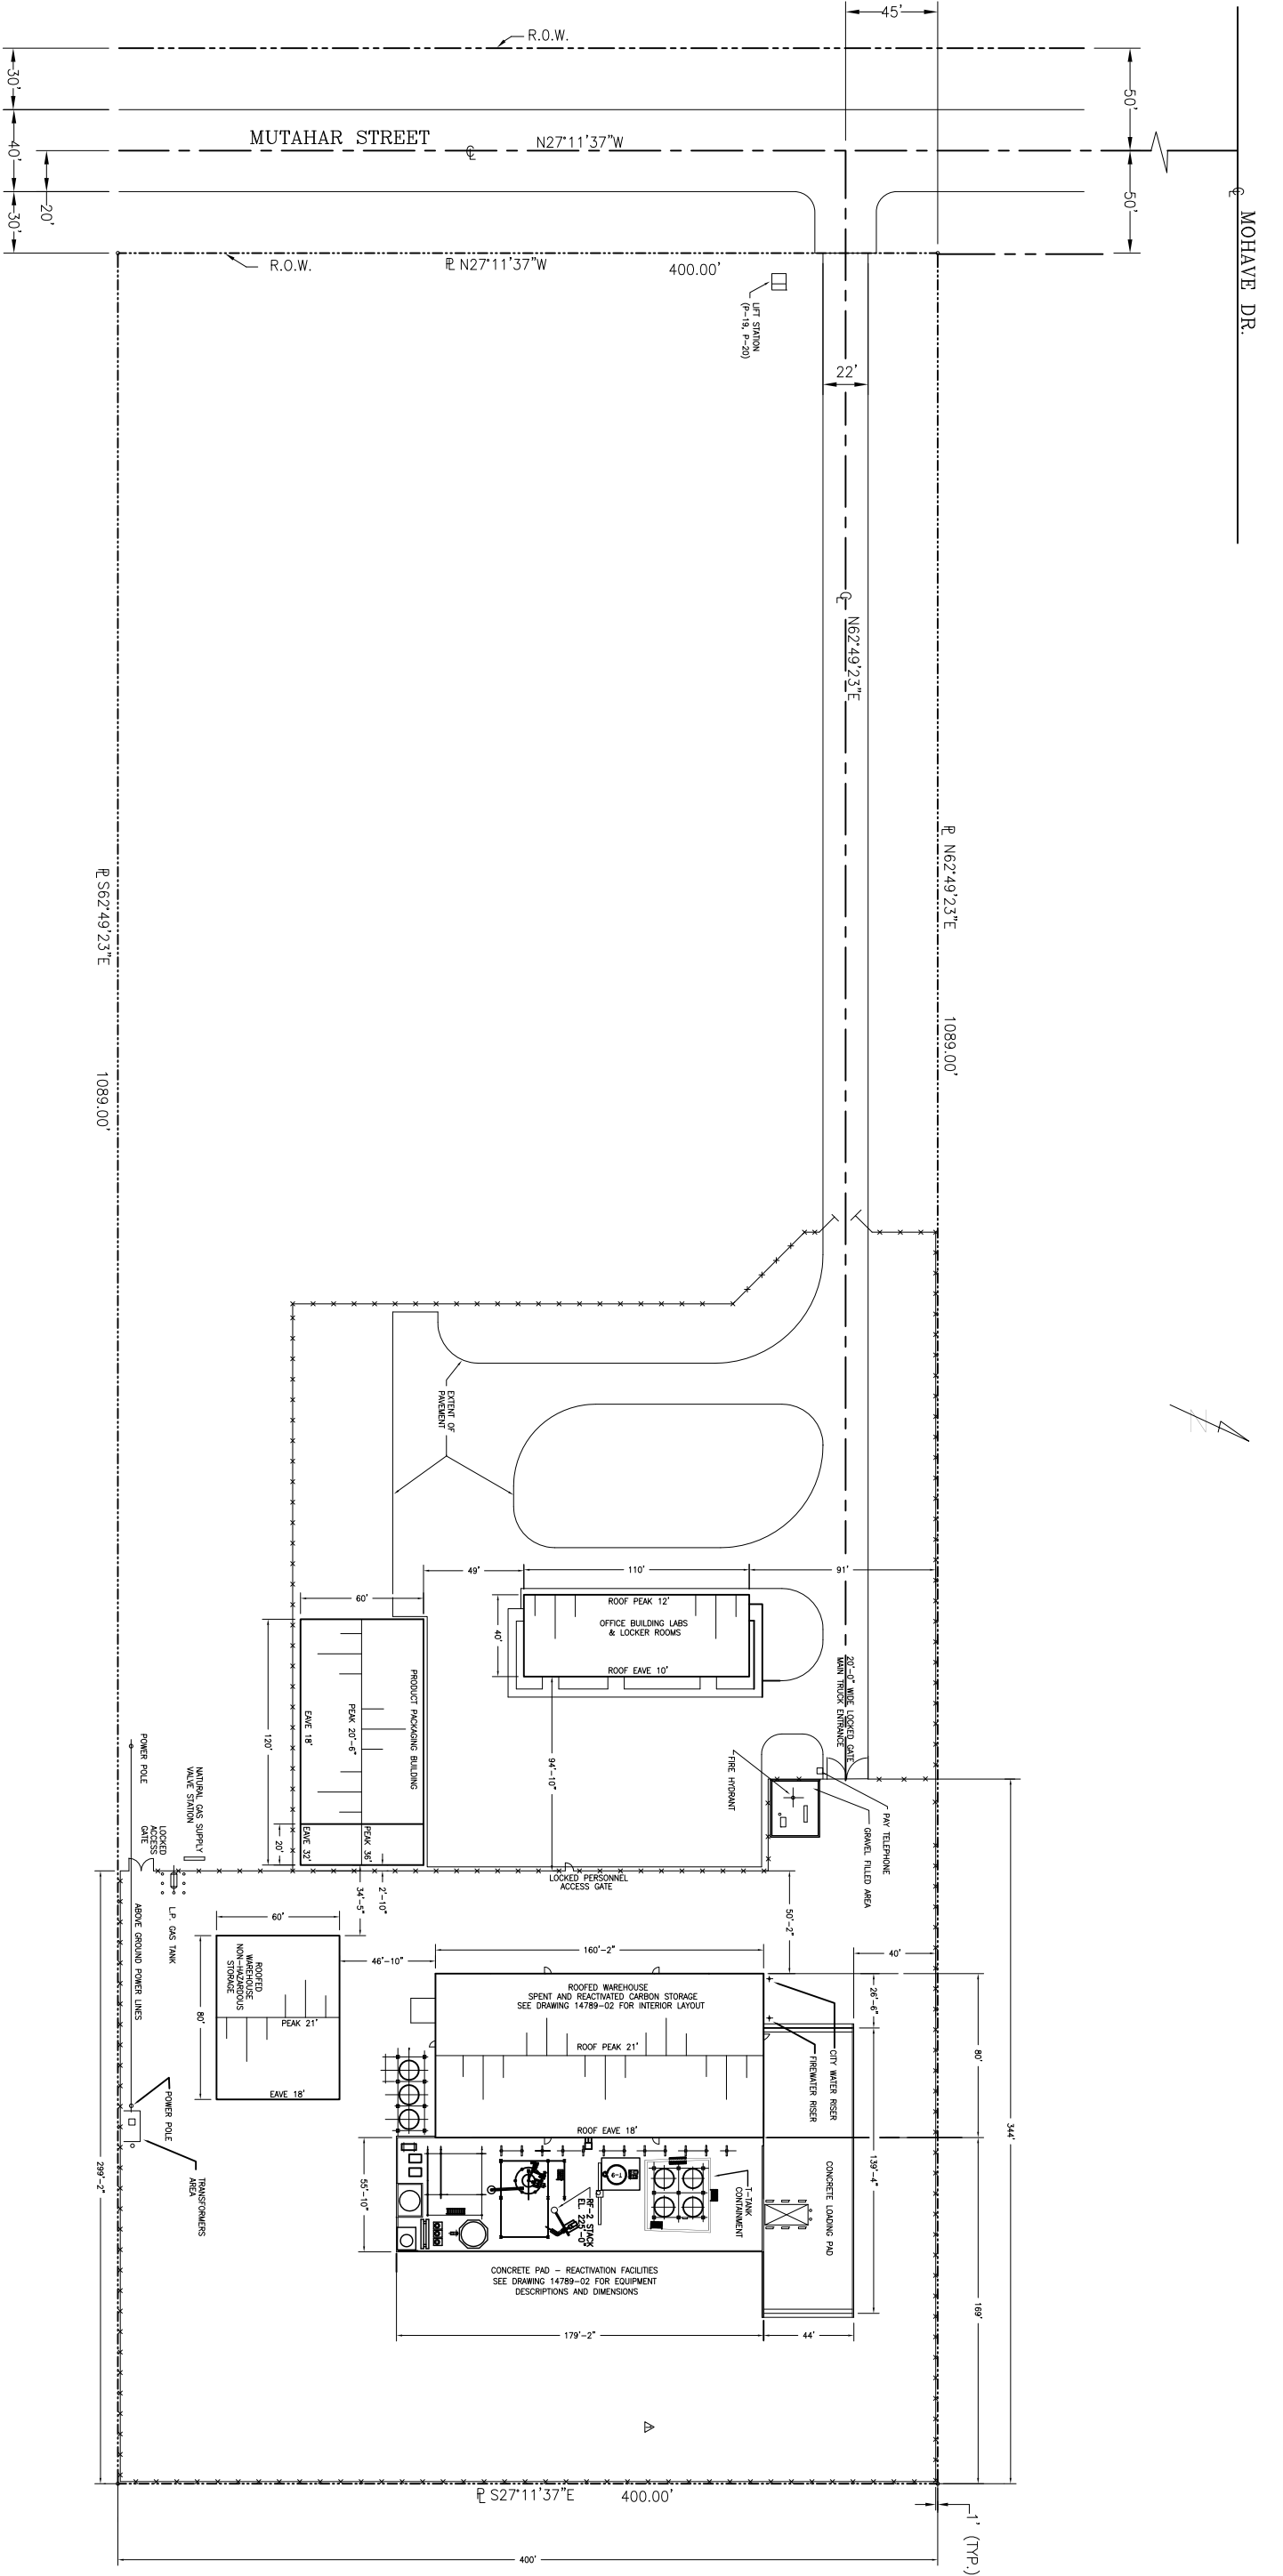

- NOTES:**
- THIS DRAWING INCLUDES COMPONENTS OF THE FACILITY THAT ARE EXEMPT FROM PERMITTING UNDER VARIOUS PROVISIONS OF RCRA. DATA RELATED TO THESE COMPONENTS IS PROVIDED FOR INFORMATIONAL PURPOSES AND EASE OF REVIEW ONLY, AND THEY ARE NOT INTENDED TO BECOME REGULATED COMPONENTS OF THE HAZARDOUS WASTE FACILITY.

3	3/16/12	NAME CHANGED TO SIEMENS INDUSTRY, INC.	JBE	KEM
2	1/18/07	UPDATED FOR PERMIT SUBMITTAL	JBE	KEM
Δ	6/21/02	REMOVED DUMPSITE PAD	CPG	KEM
REV.	DATE	REVISION DESCRIPTION	DRAWN	CHK'D
CUSTOMER:		SIEMENS INDUSTRY, INC.	CHK'D	ENGR
LOCATION:		SIEMENS INDUSTRY, INC.		
		2523 MUTAHAR ST.		
		PARKER, AZ 85344		
PROJECT NO.		TITLE:		
DRAWN: CPG		3/01/02	REACTIVATION FACILITY	
CHK'D: KEM		3/01/02	SITE PLAN	
ENGR:				
		PART No.	DWG No.	REV.
			D14789-08	3

ATTACHMENT D – Item 13 – Photographs

SITE PHOTOGRAPHS

SITE AERIAL PHOTOGRAPHS

AERIAL PHOTOGRAPHS OF THE FACILITY



PROCESS CODE S01
(Identified as Line Number 1)

Spent Carbon Warehouse



PROCESS CODE S02
(Identified as Line Number 2)

Spent Carbon Storage Feed Tanks
(Tank No. T-1 and T-2)



PROCESS CODE S02
(Identified as Line Number 2)

Spent Carbon Storage Feed Tanks
(Tank No. T-2, T-5 and T-6)



PROCESS CODE X03
(Identified as Line Number 3)

Carbon Reactivation Furnace RF-2

